

TERRENO GARDENA

1855 W. 139TH ST. GARDENA, CA 90249

PLANNING CUP COMMENTS - 05.20.2025

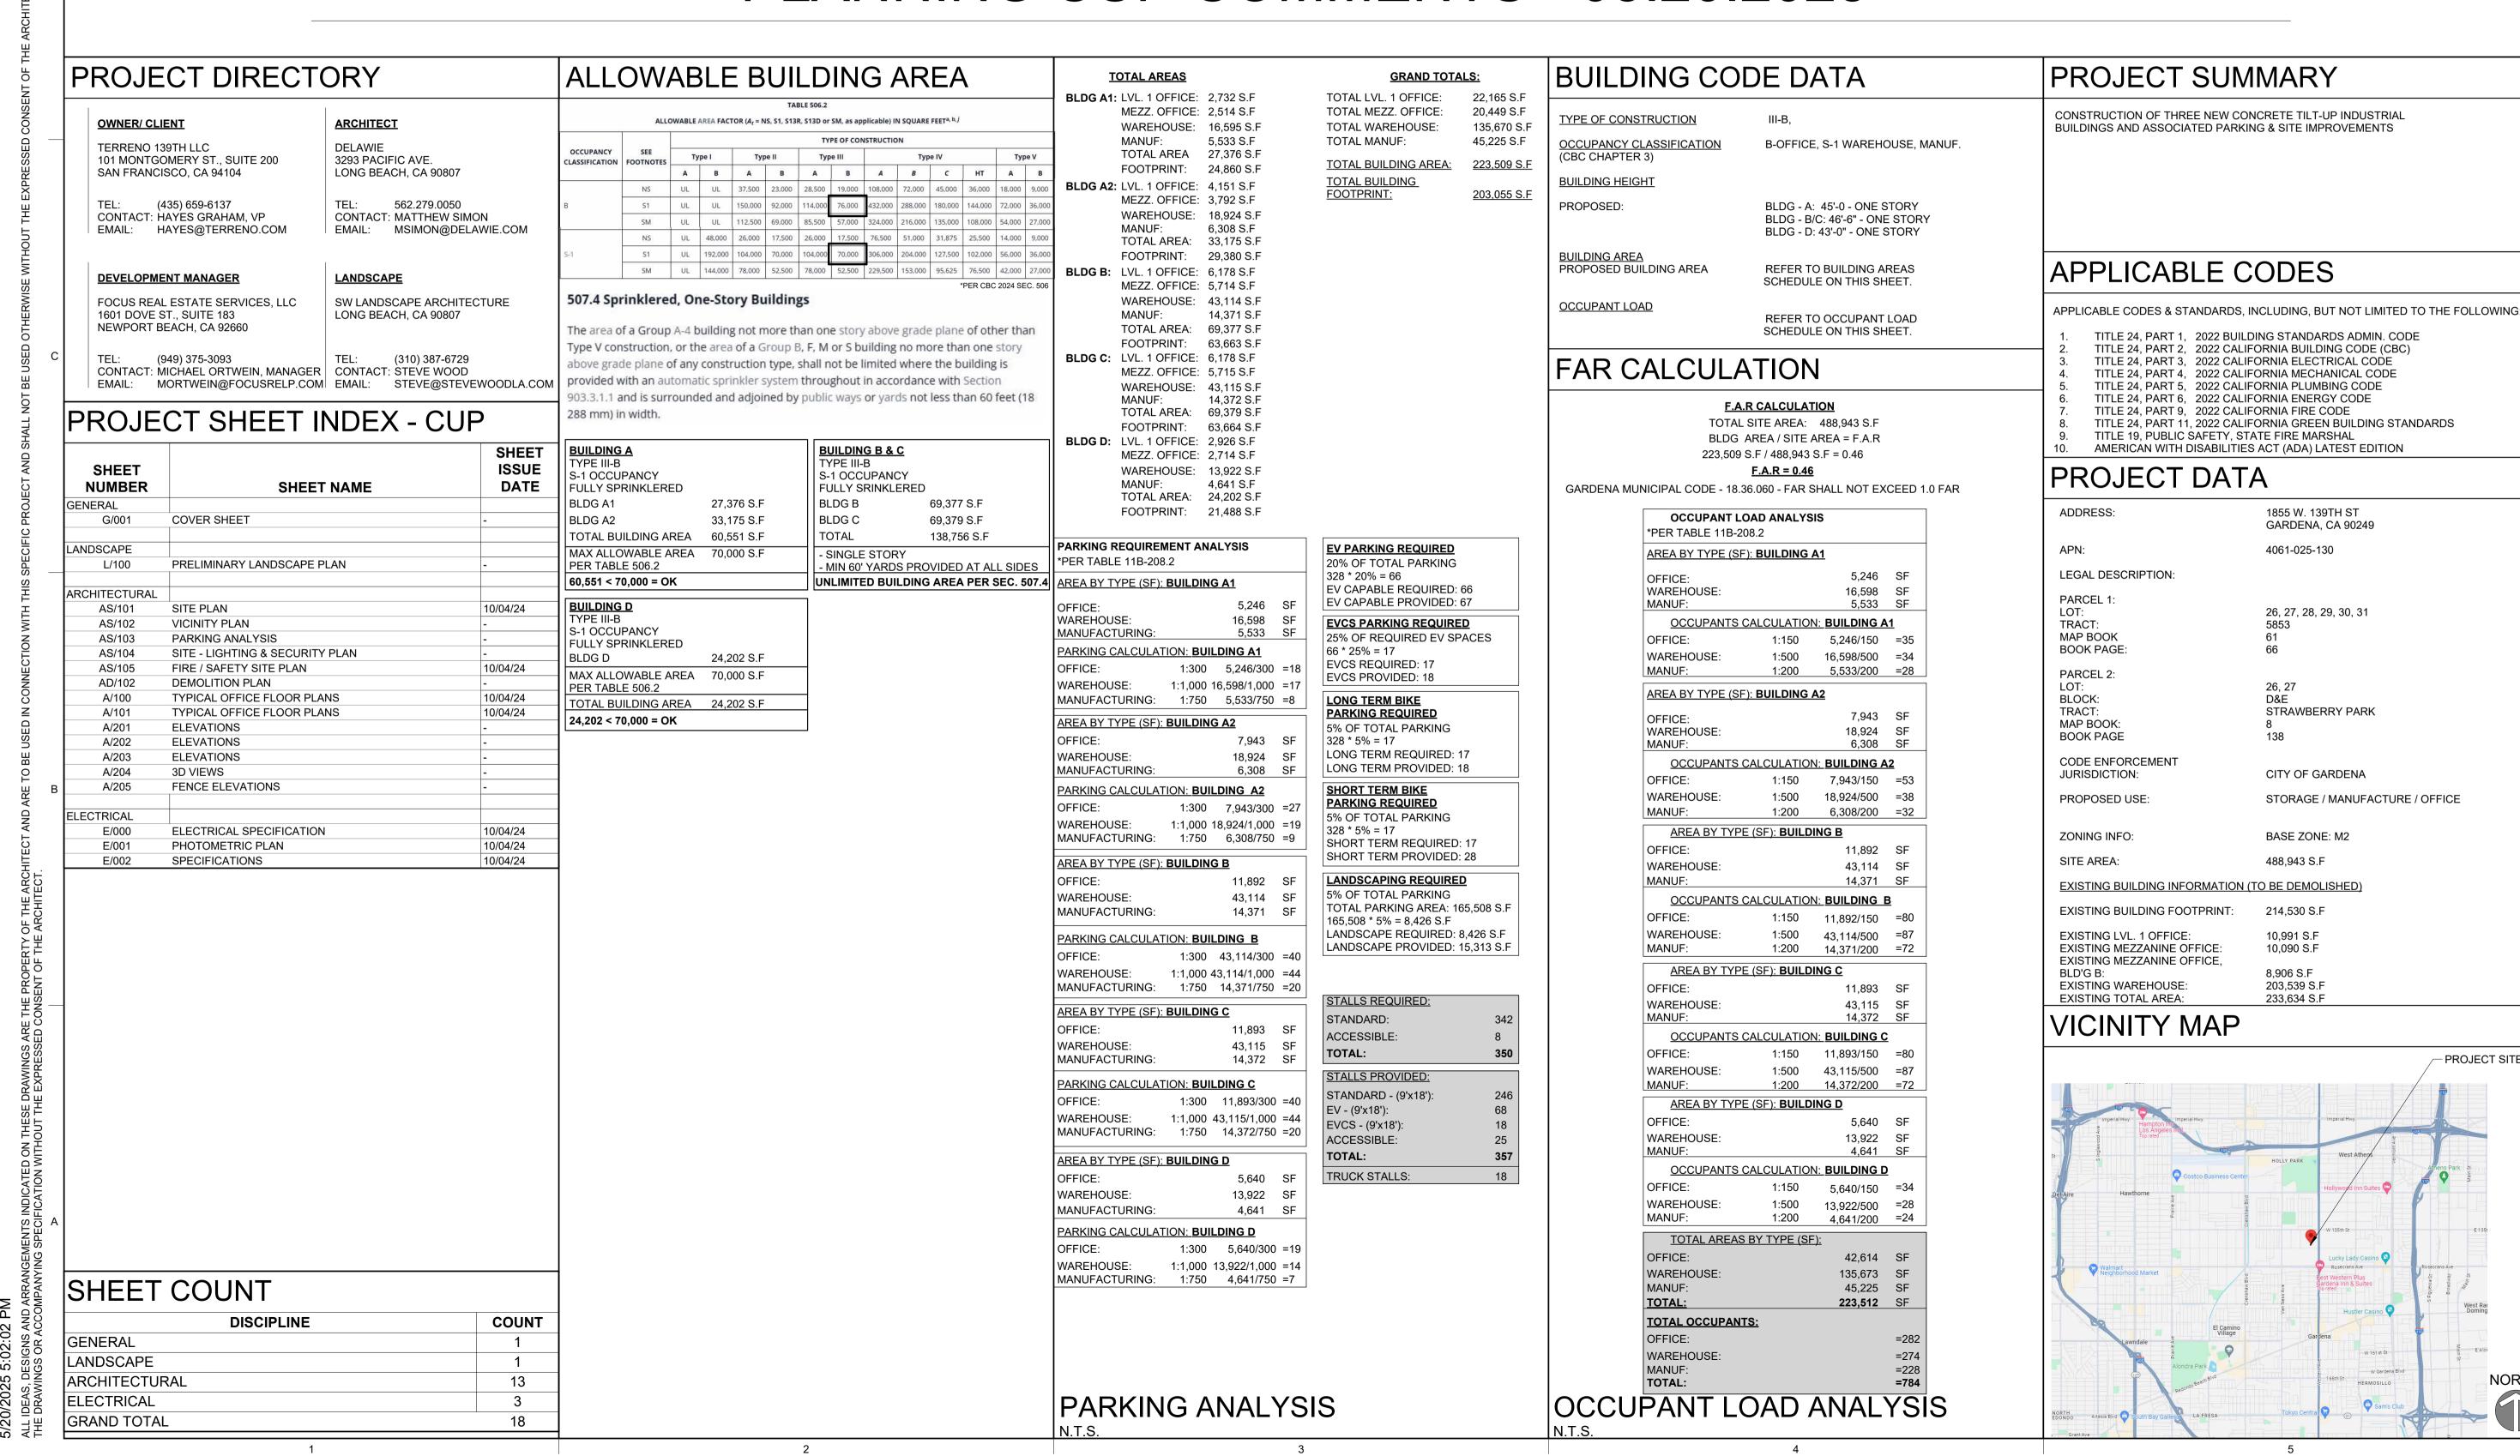

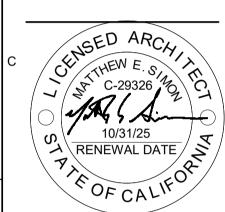

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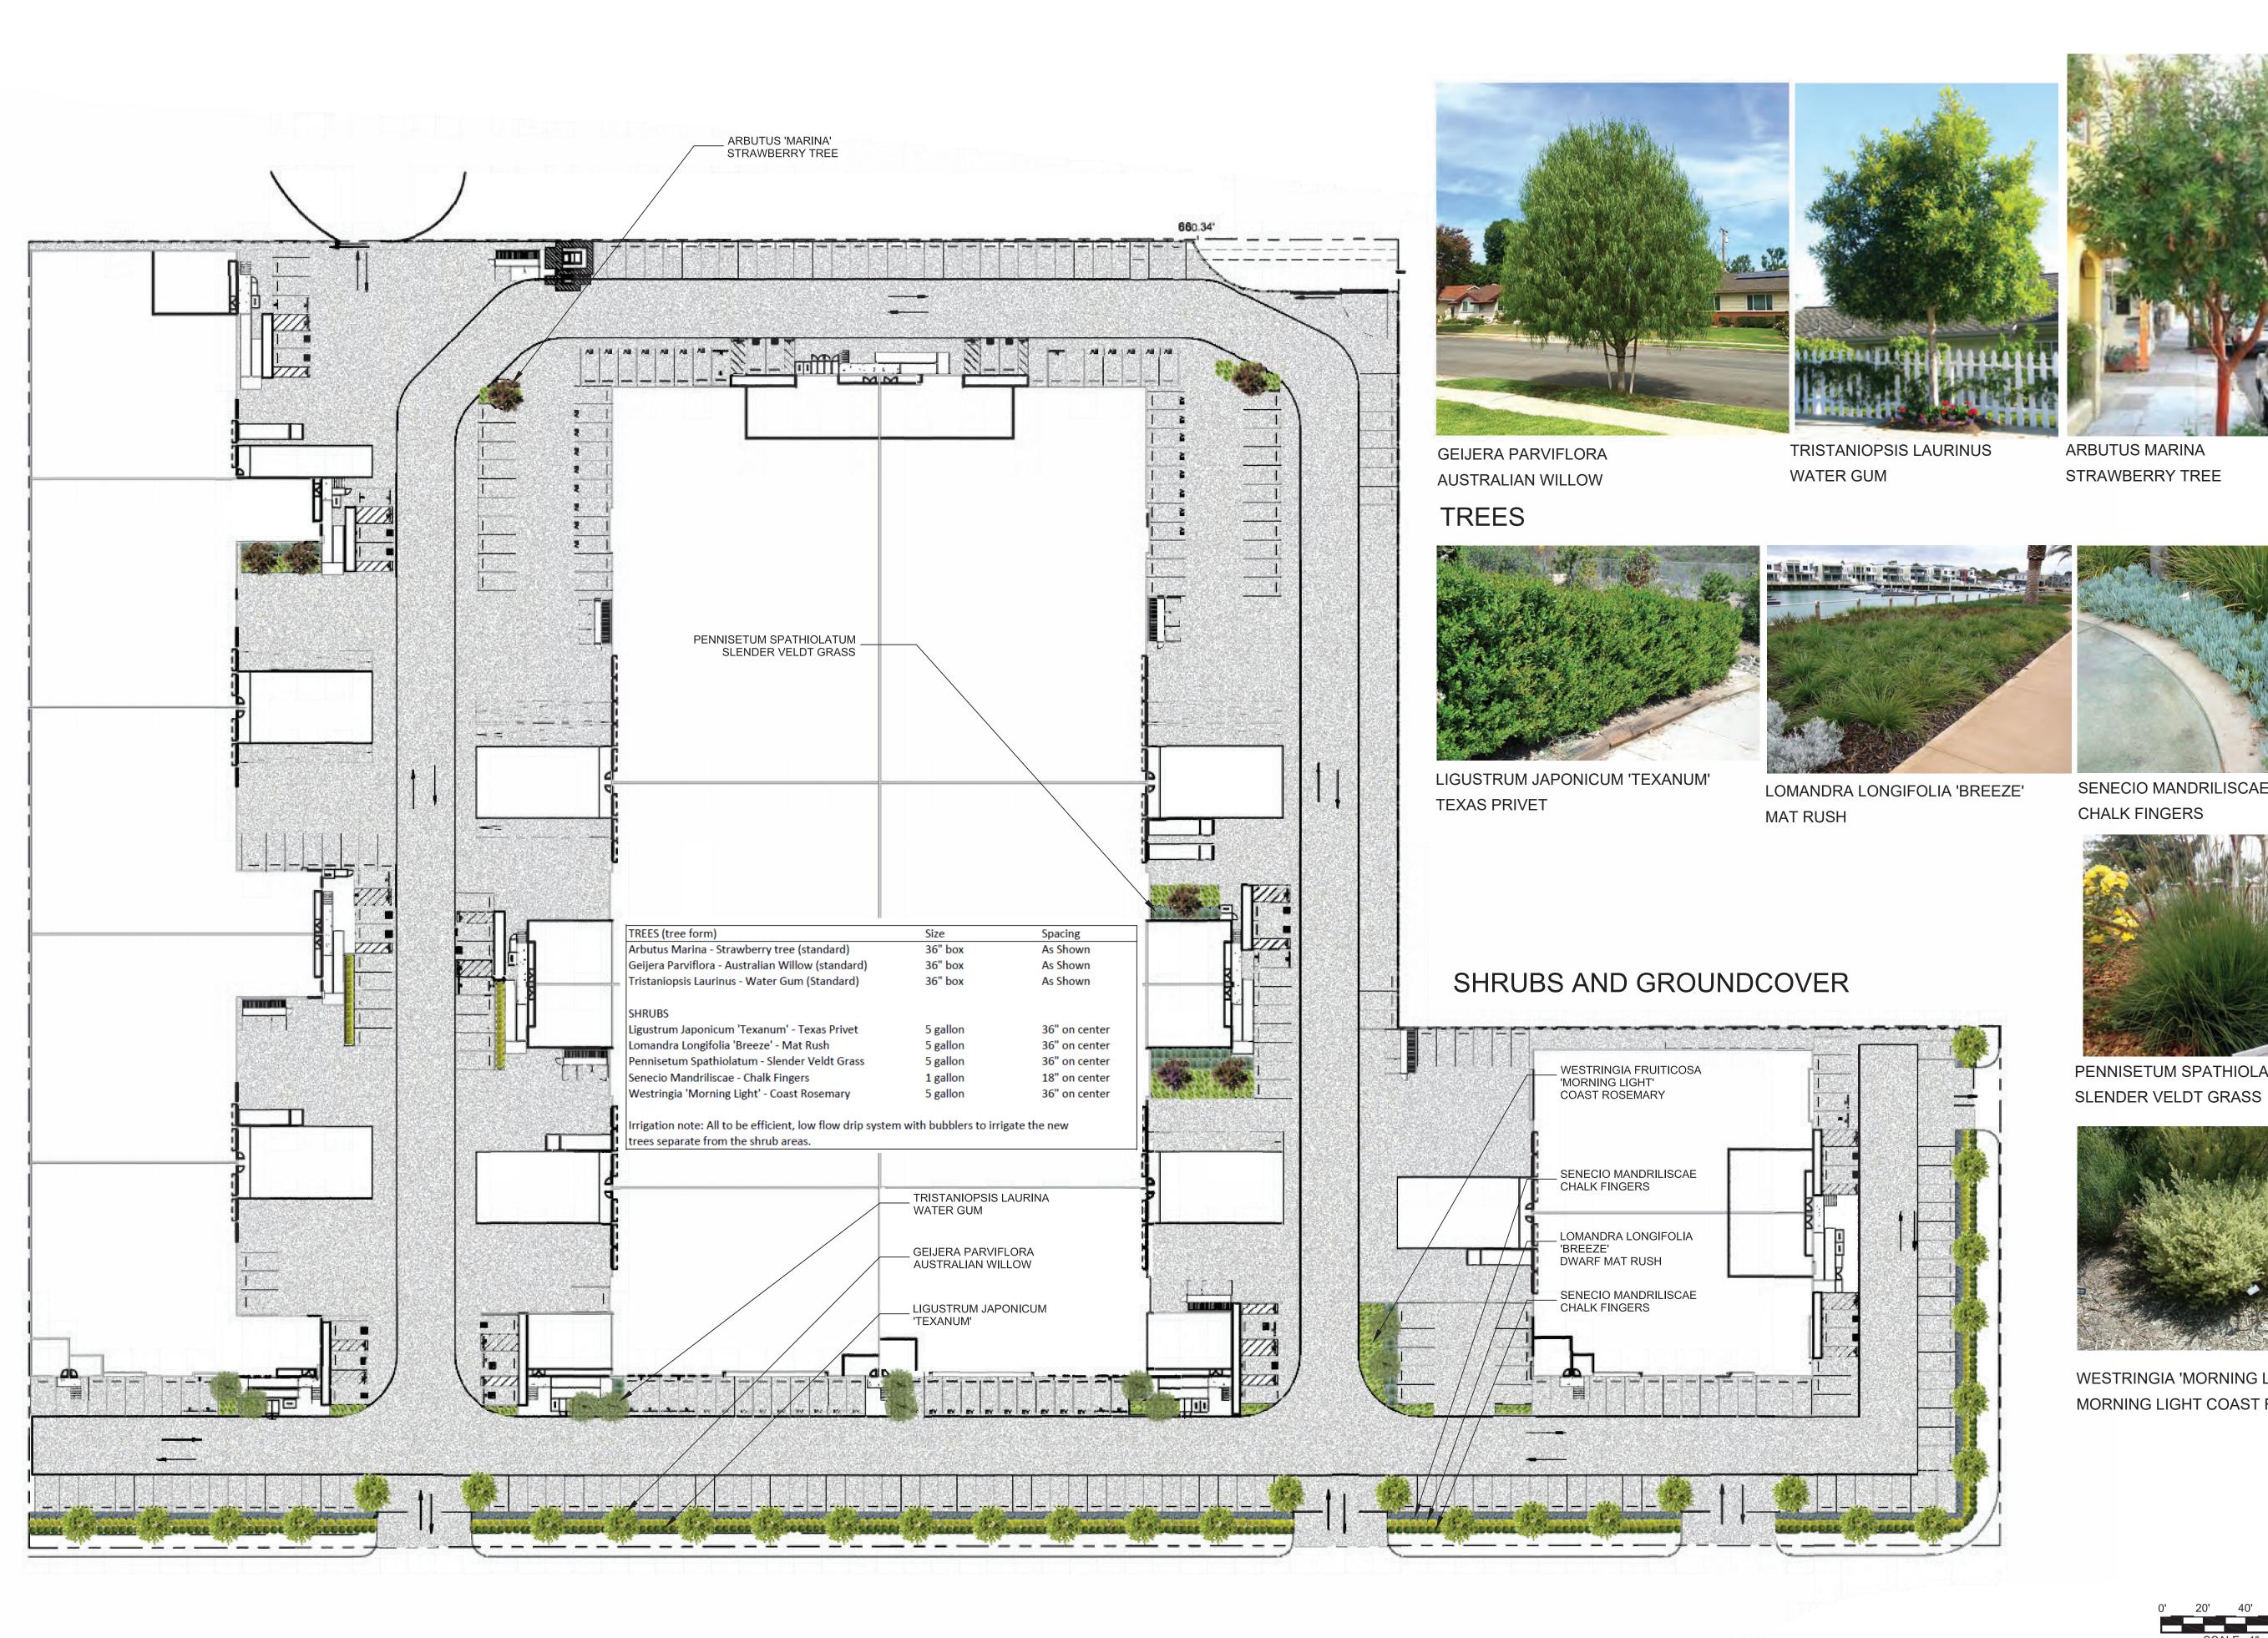
23338.LA PROJ. NO. REV DATE NO. ISSUED

05.20.2025 PLANNING CUP COMMENTS

- PROJECT SITE

COVER SHEET

G/001



PRELIMINARY LANDSCAPE PLAN

1" = 40'-0"



23338.LA

SENECIO MANDRILISCAE CHALK FINGERS



PENNISETUM SPATHIOLATUM




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Issue Date Project Status - 0%


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REV DATE NO. ISSUED

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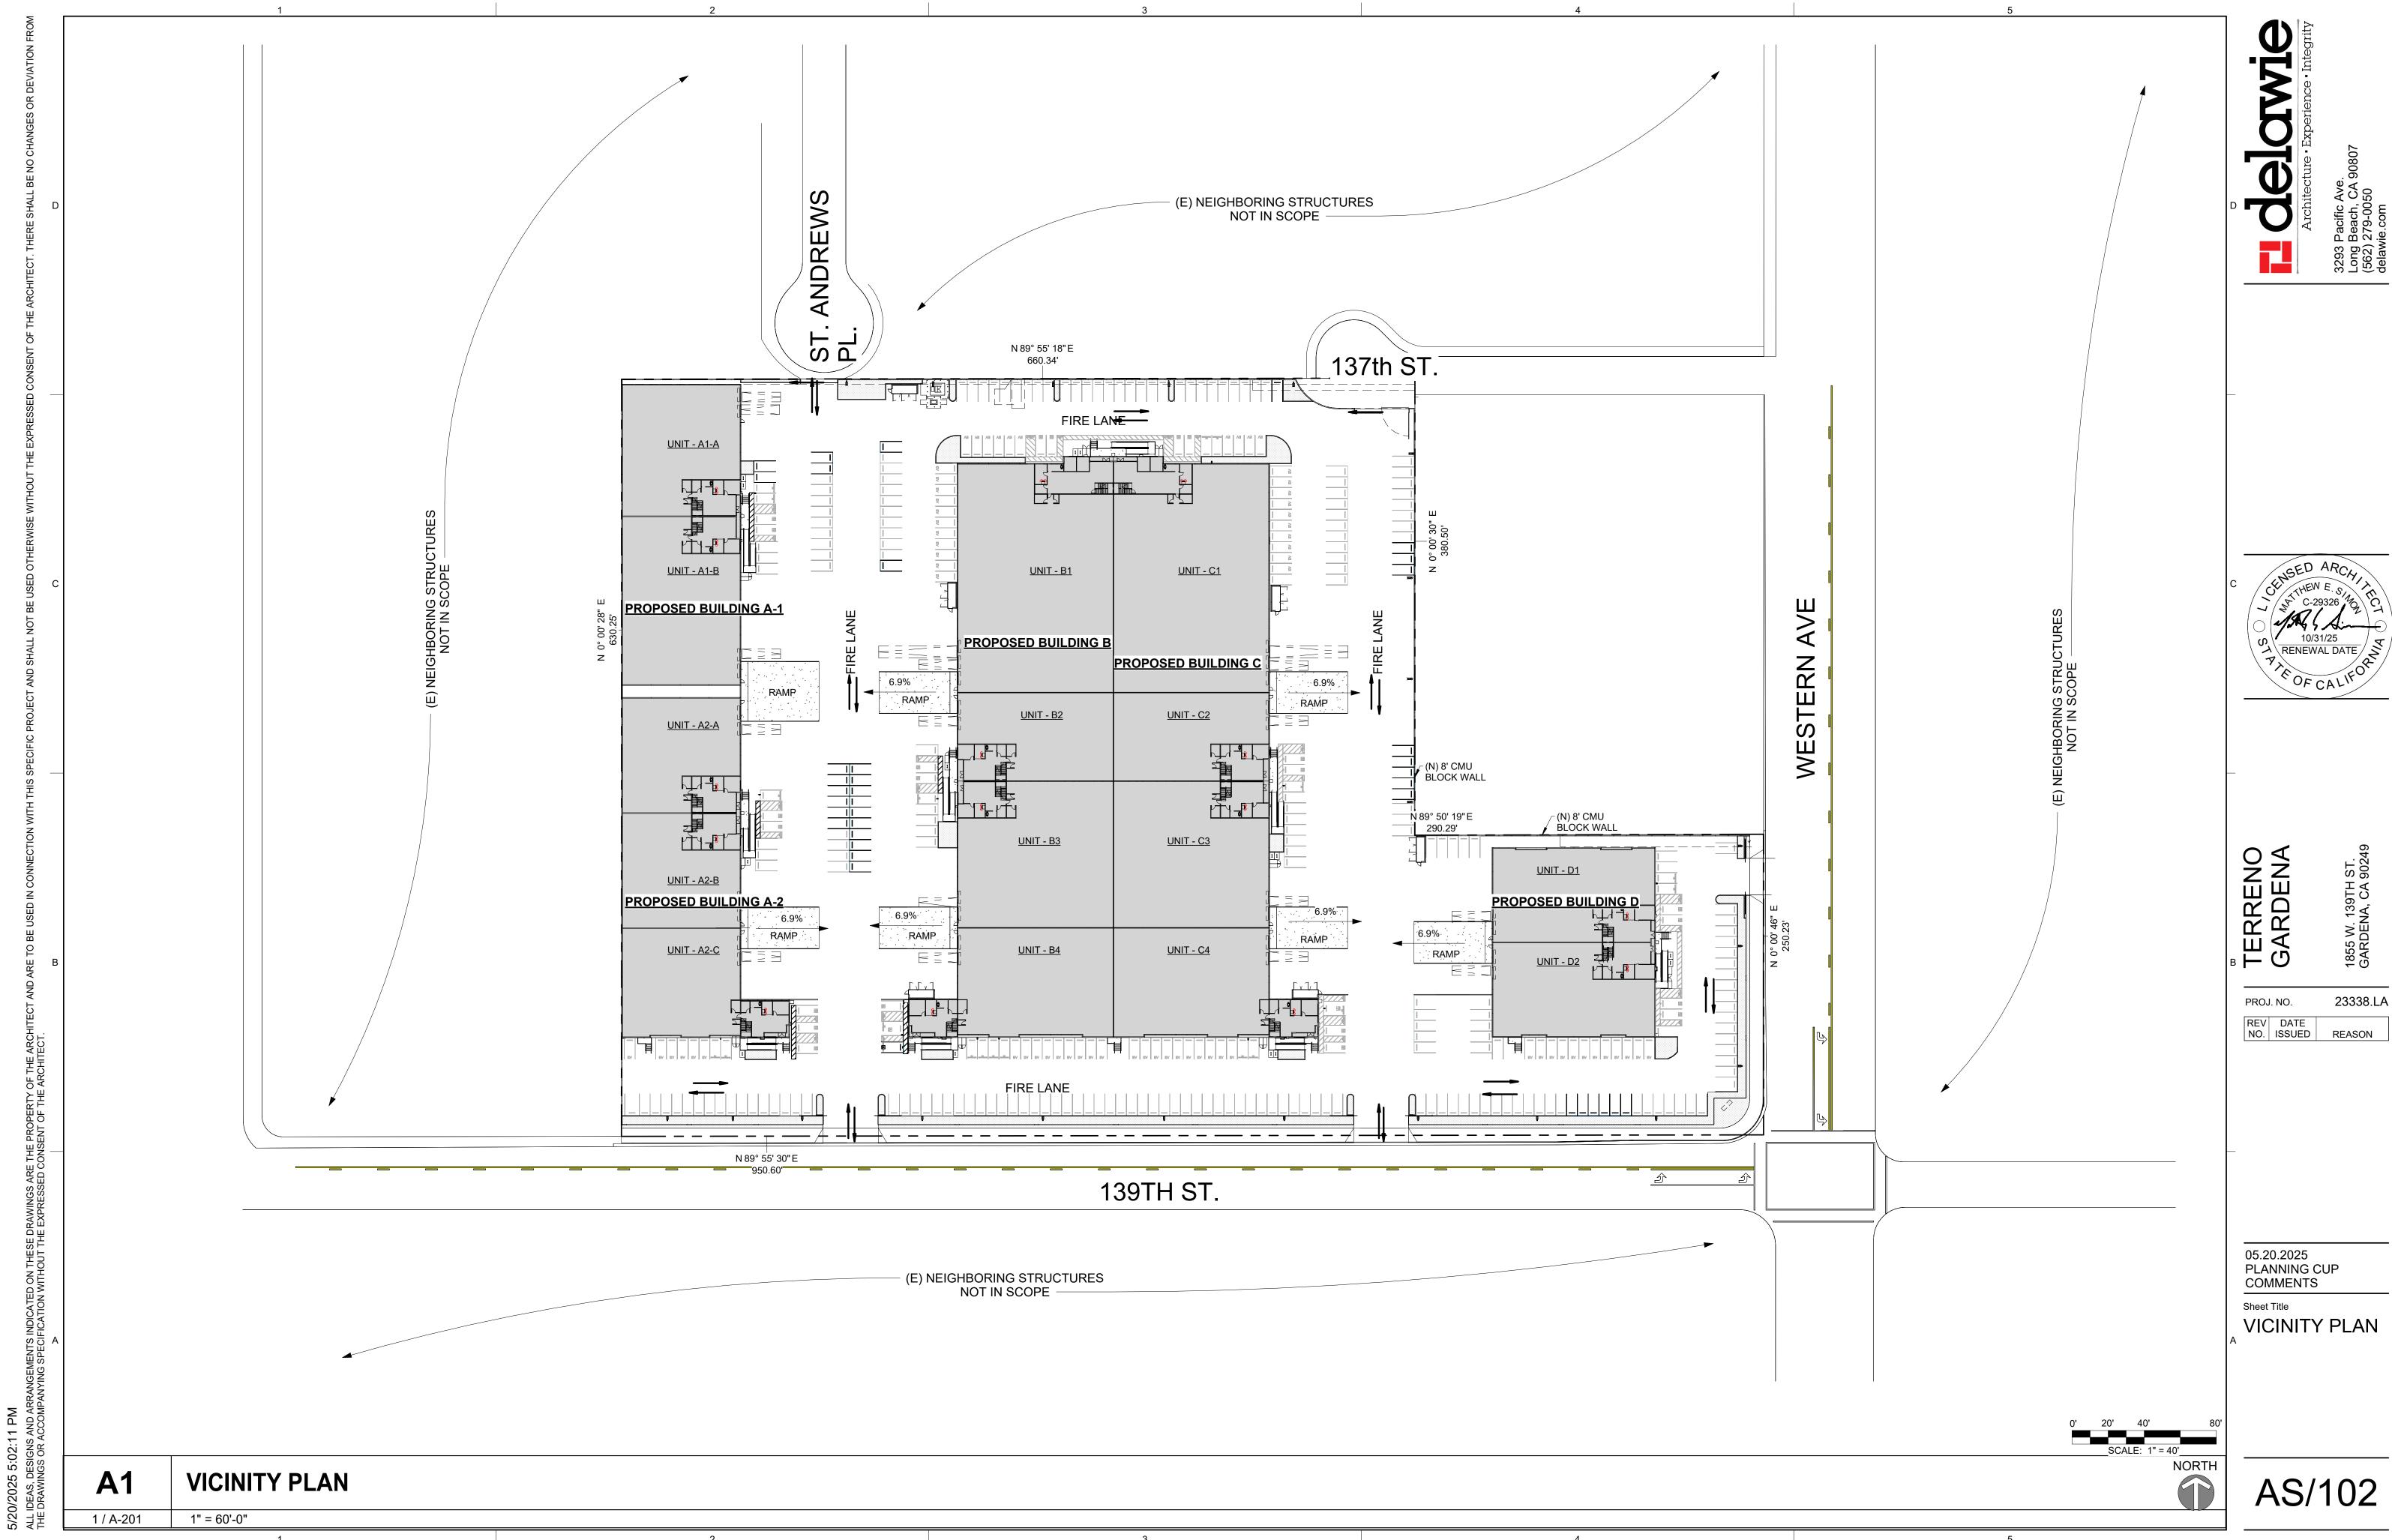



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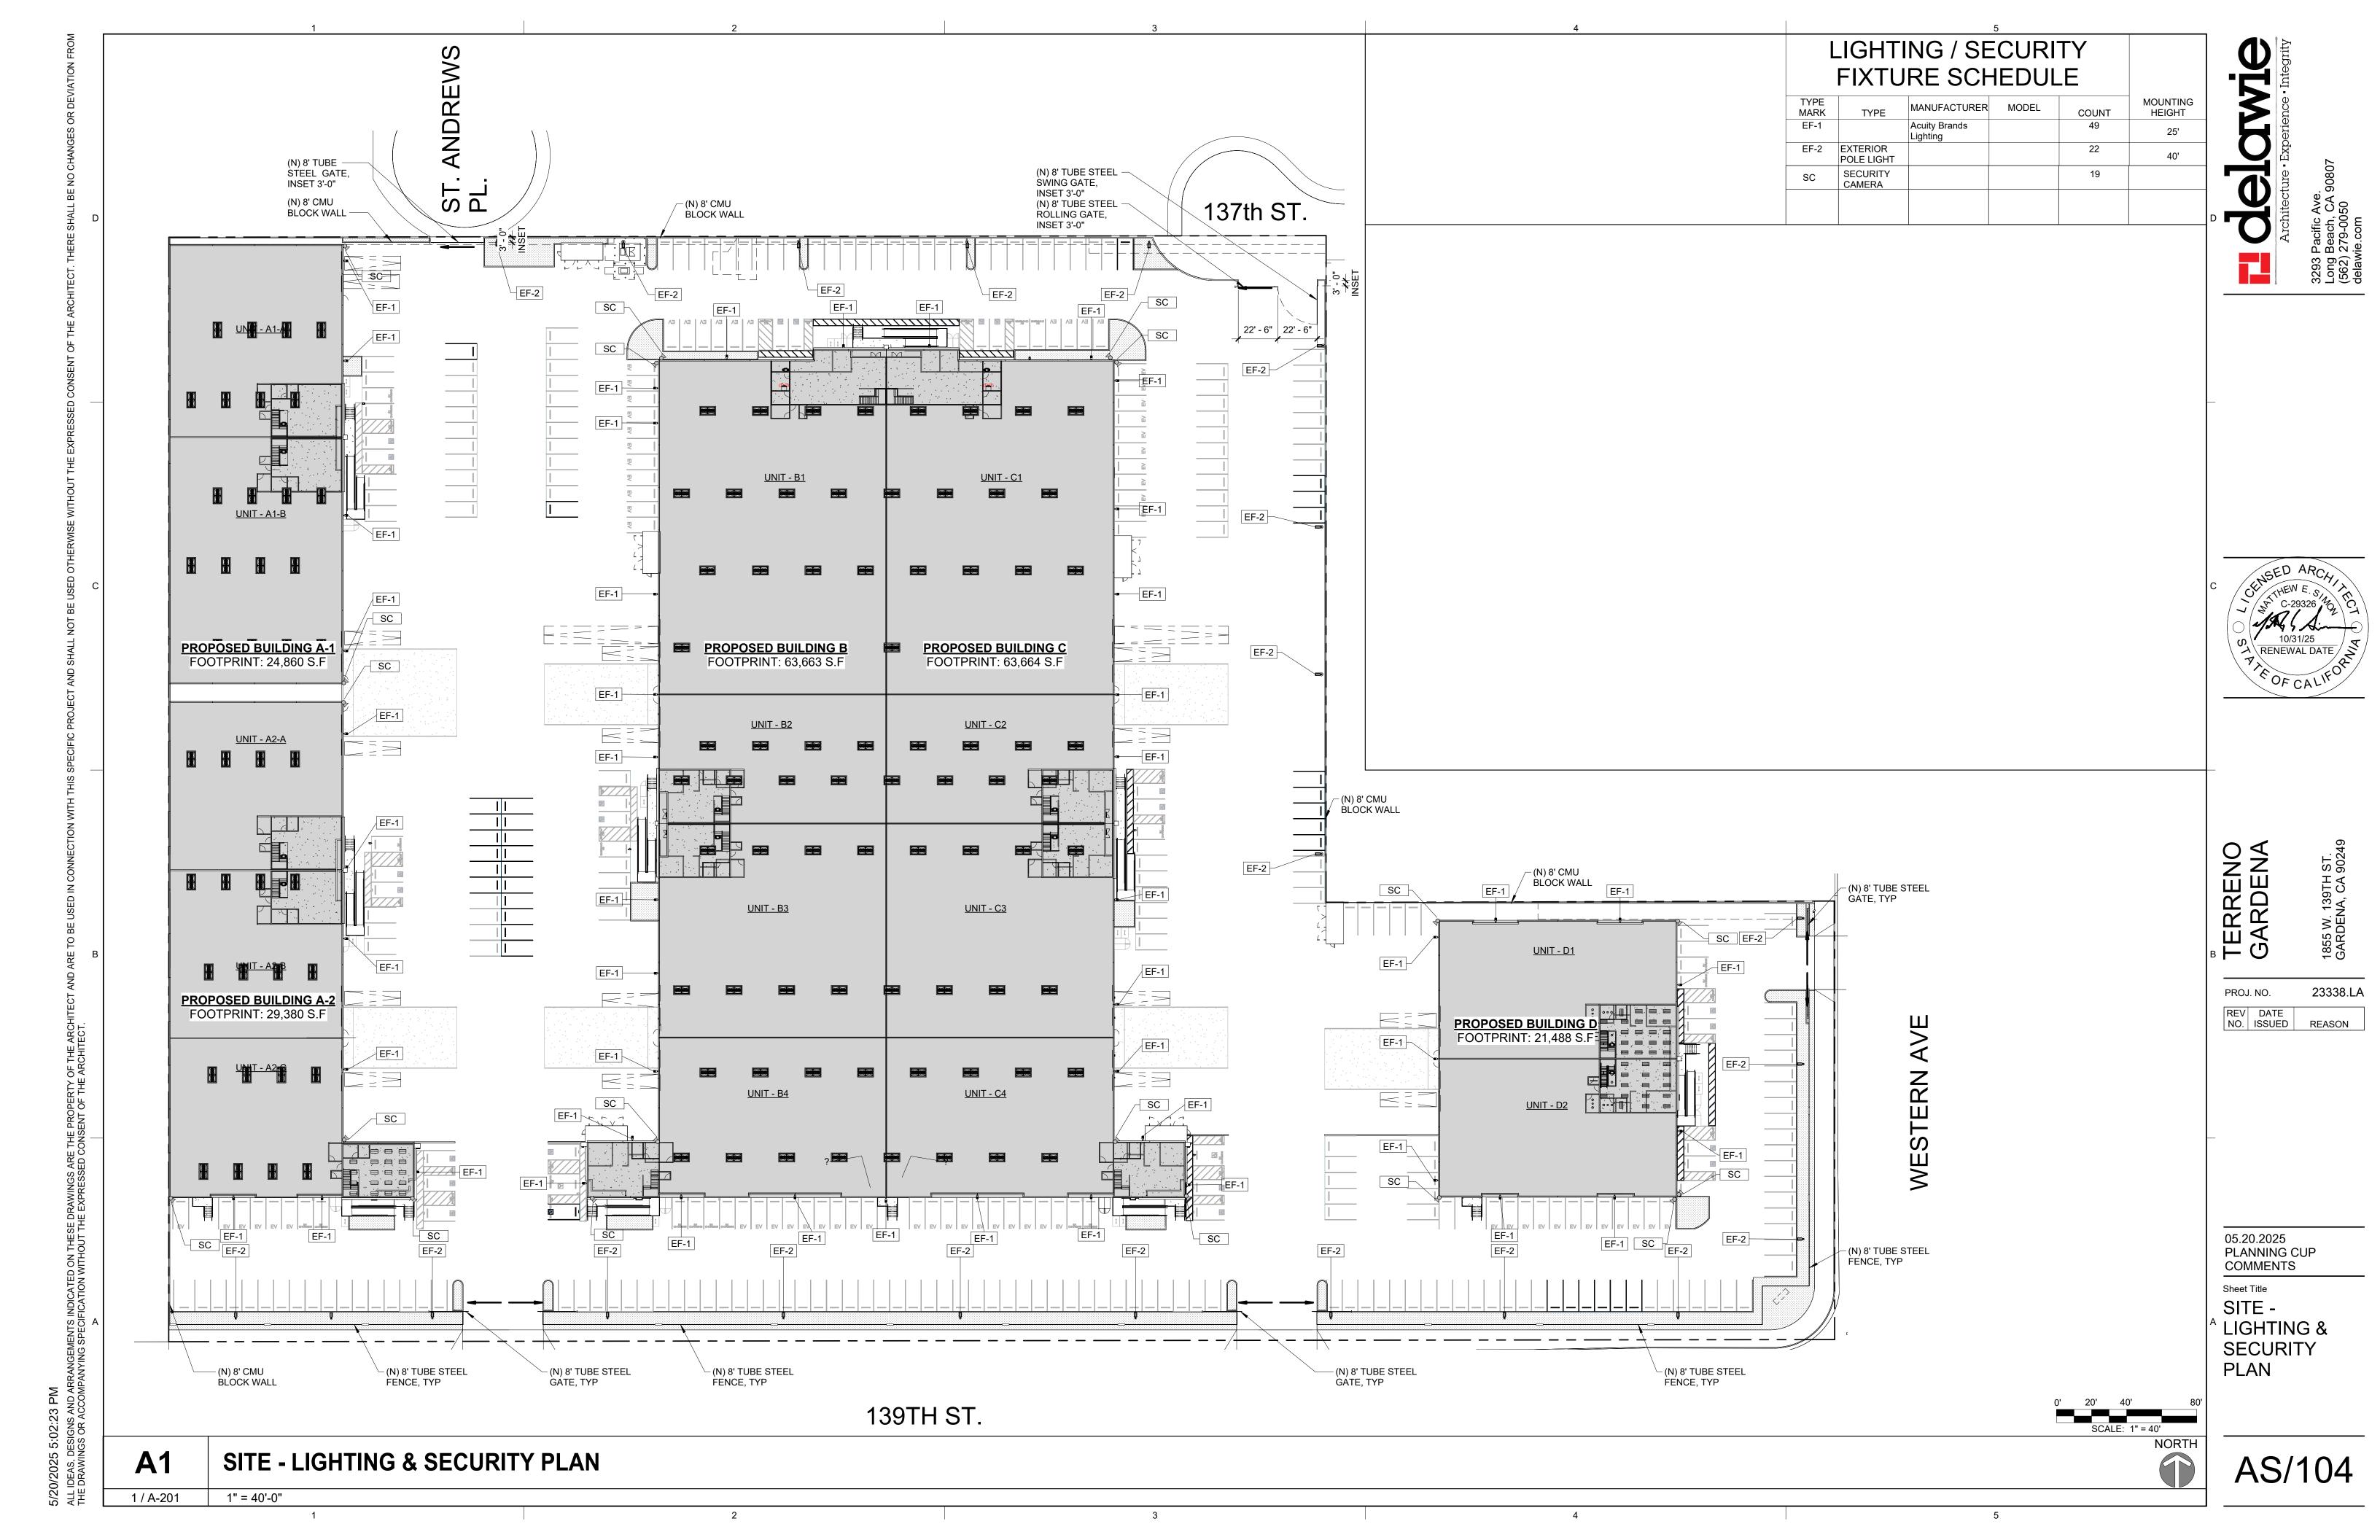
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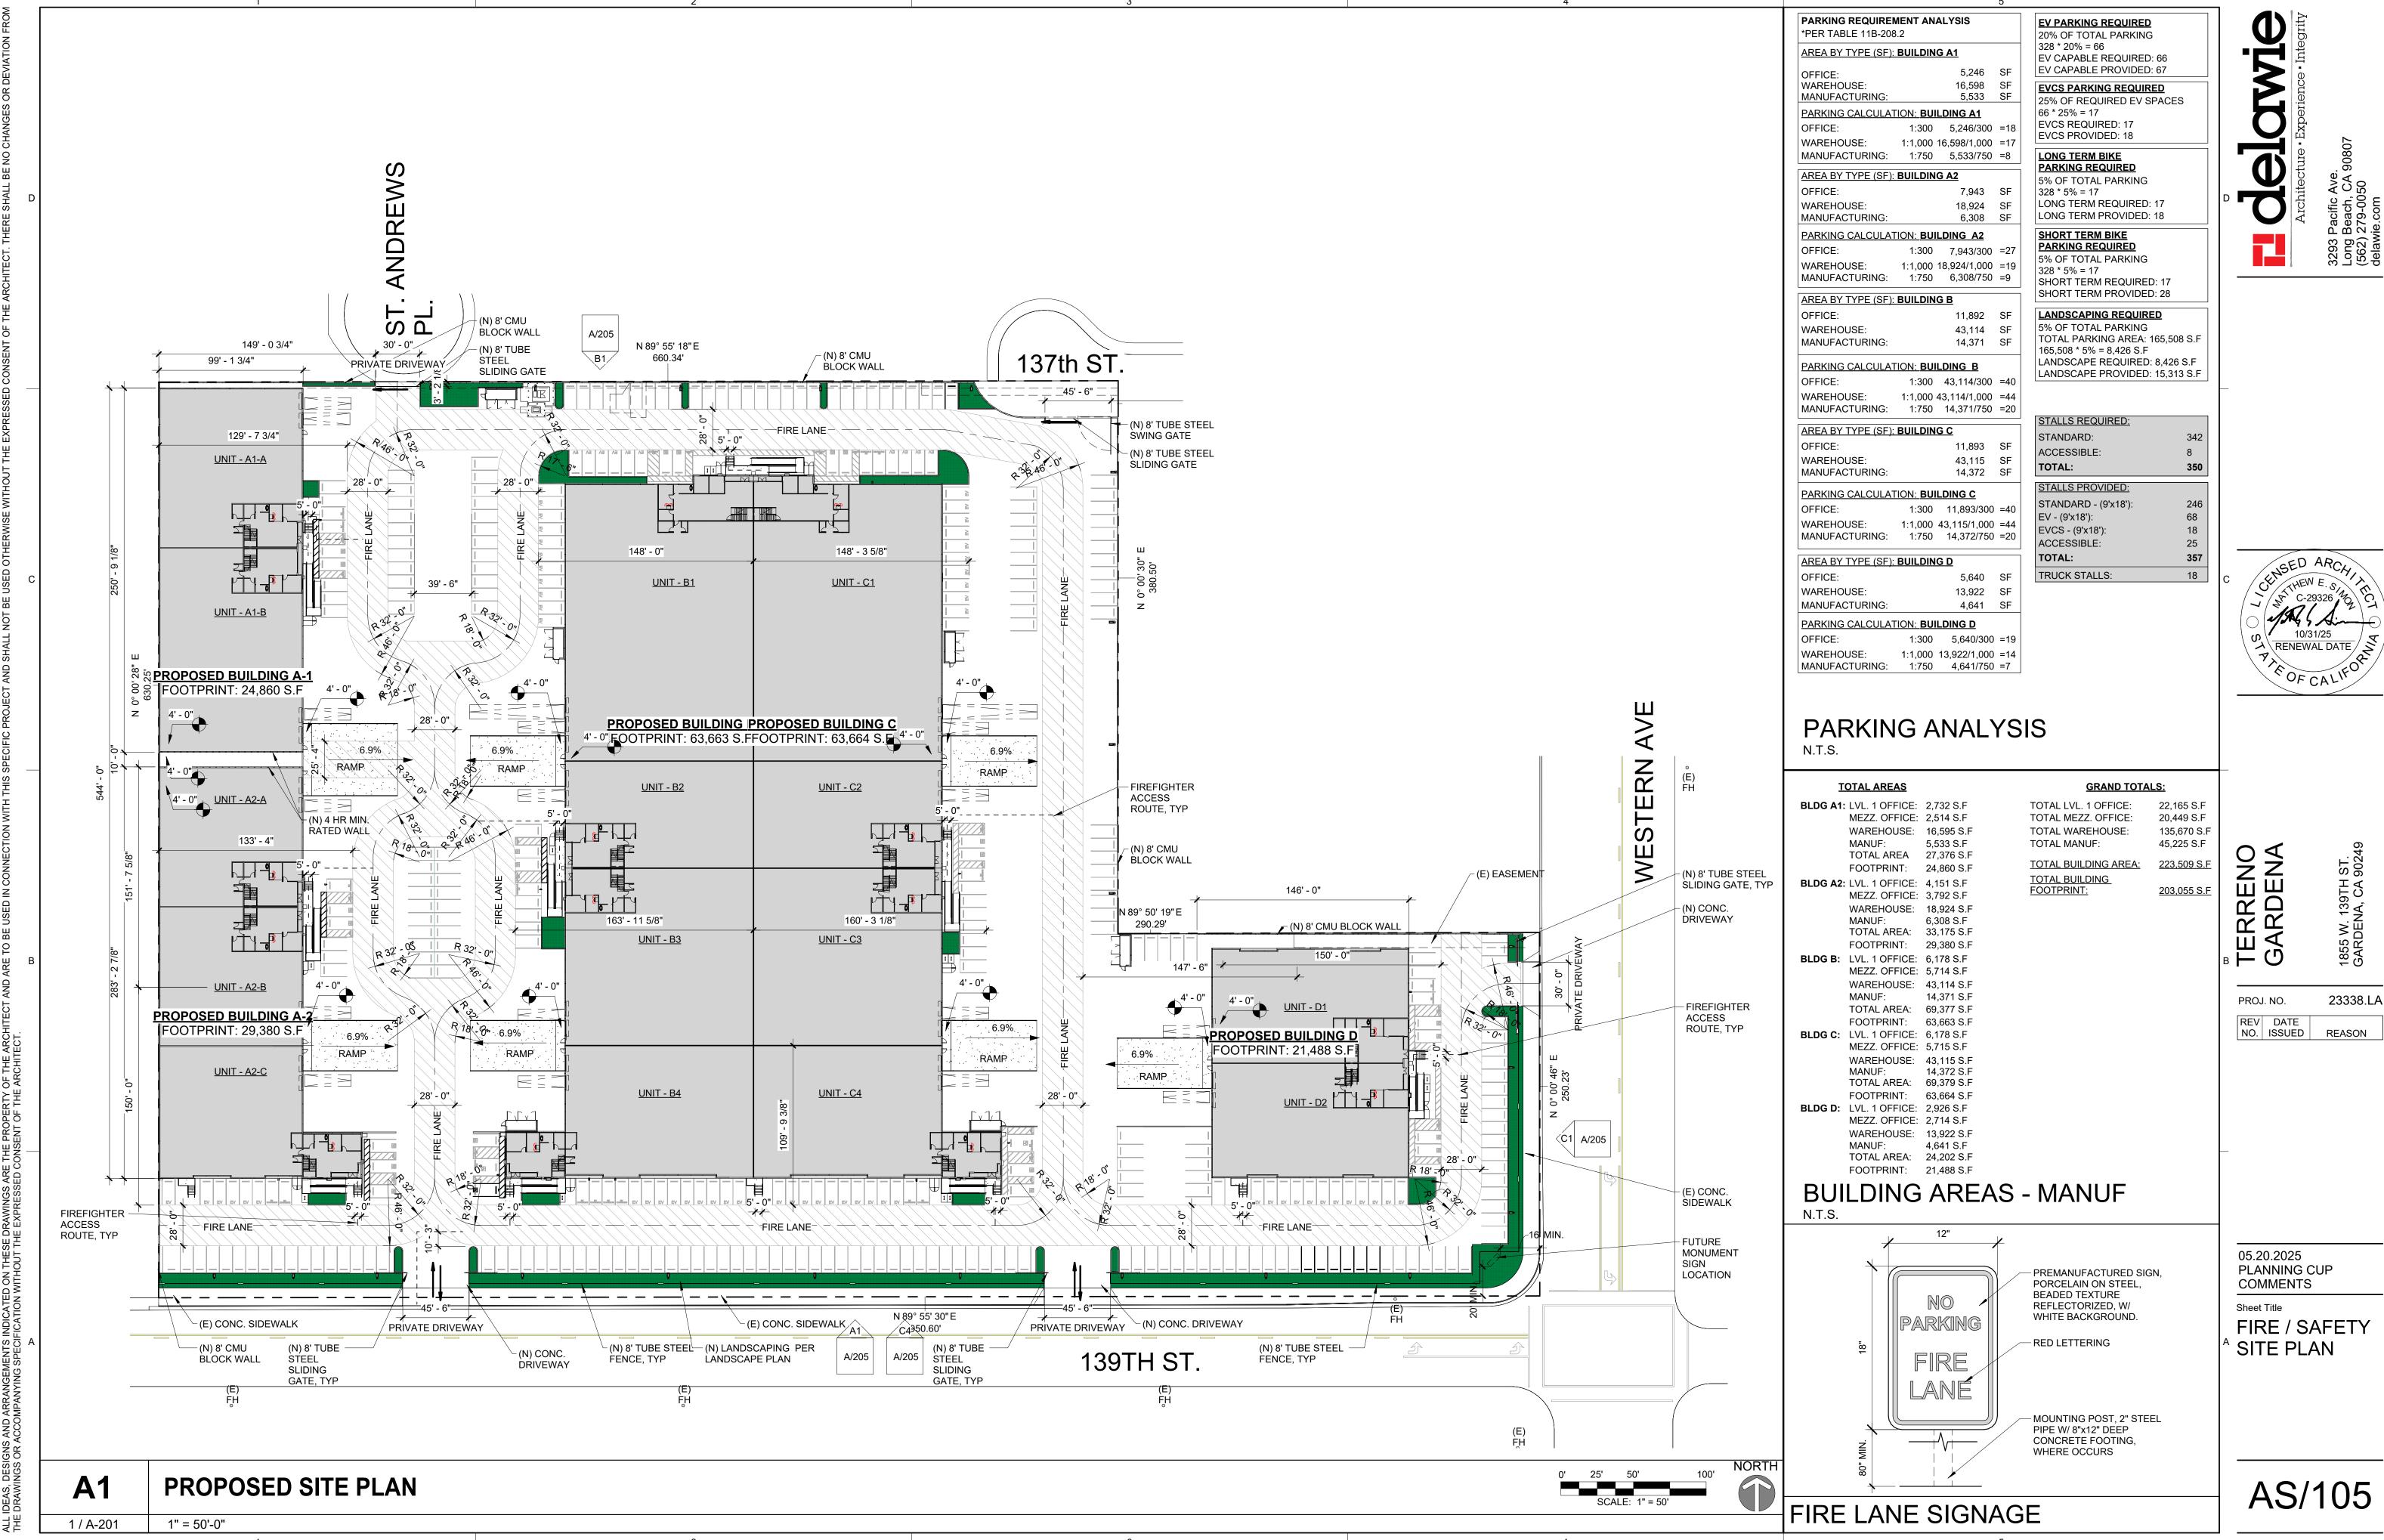
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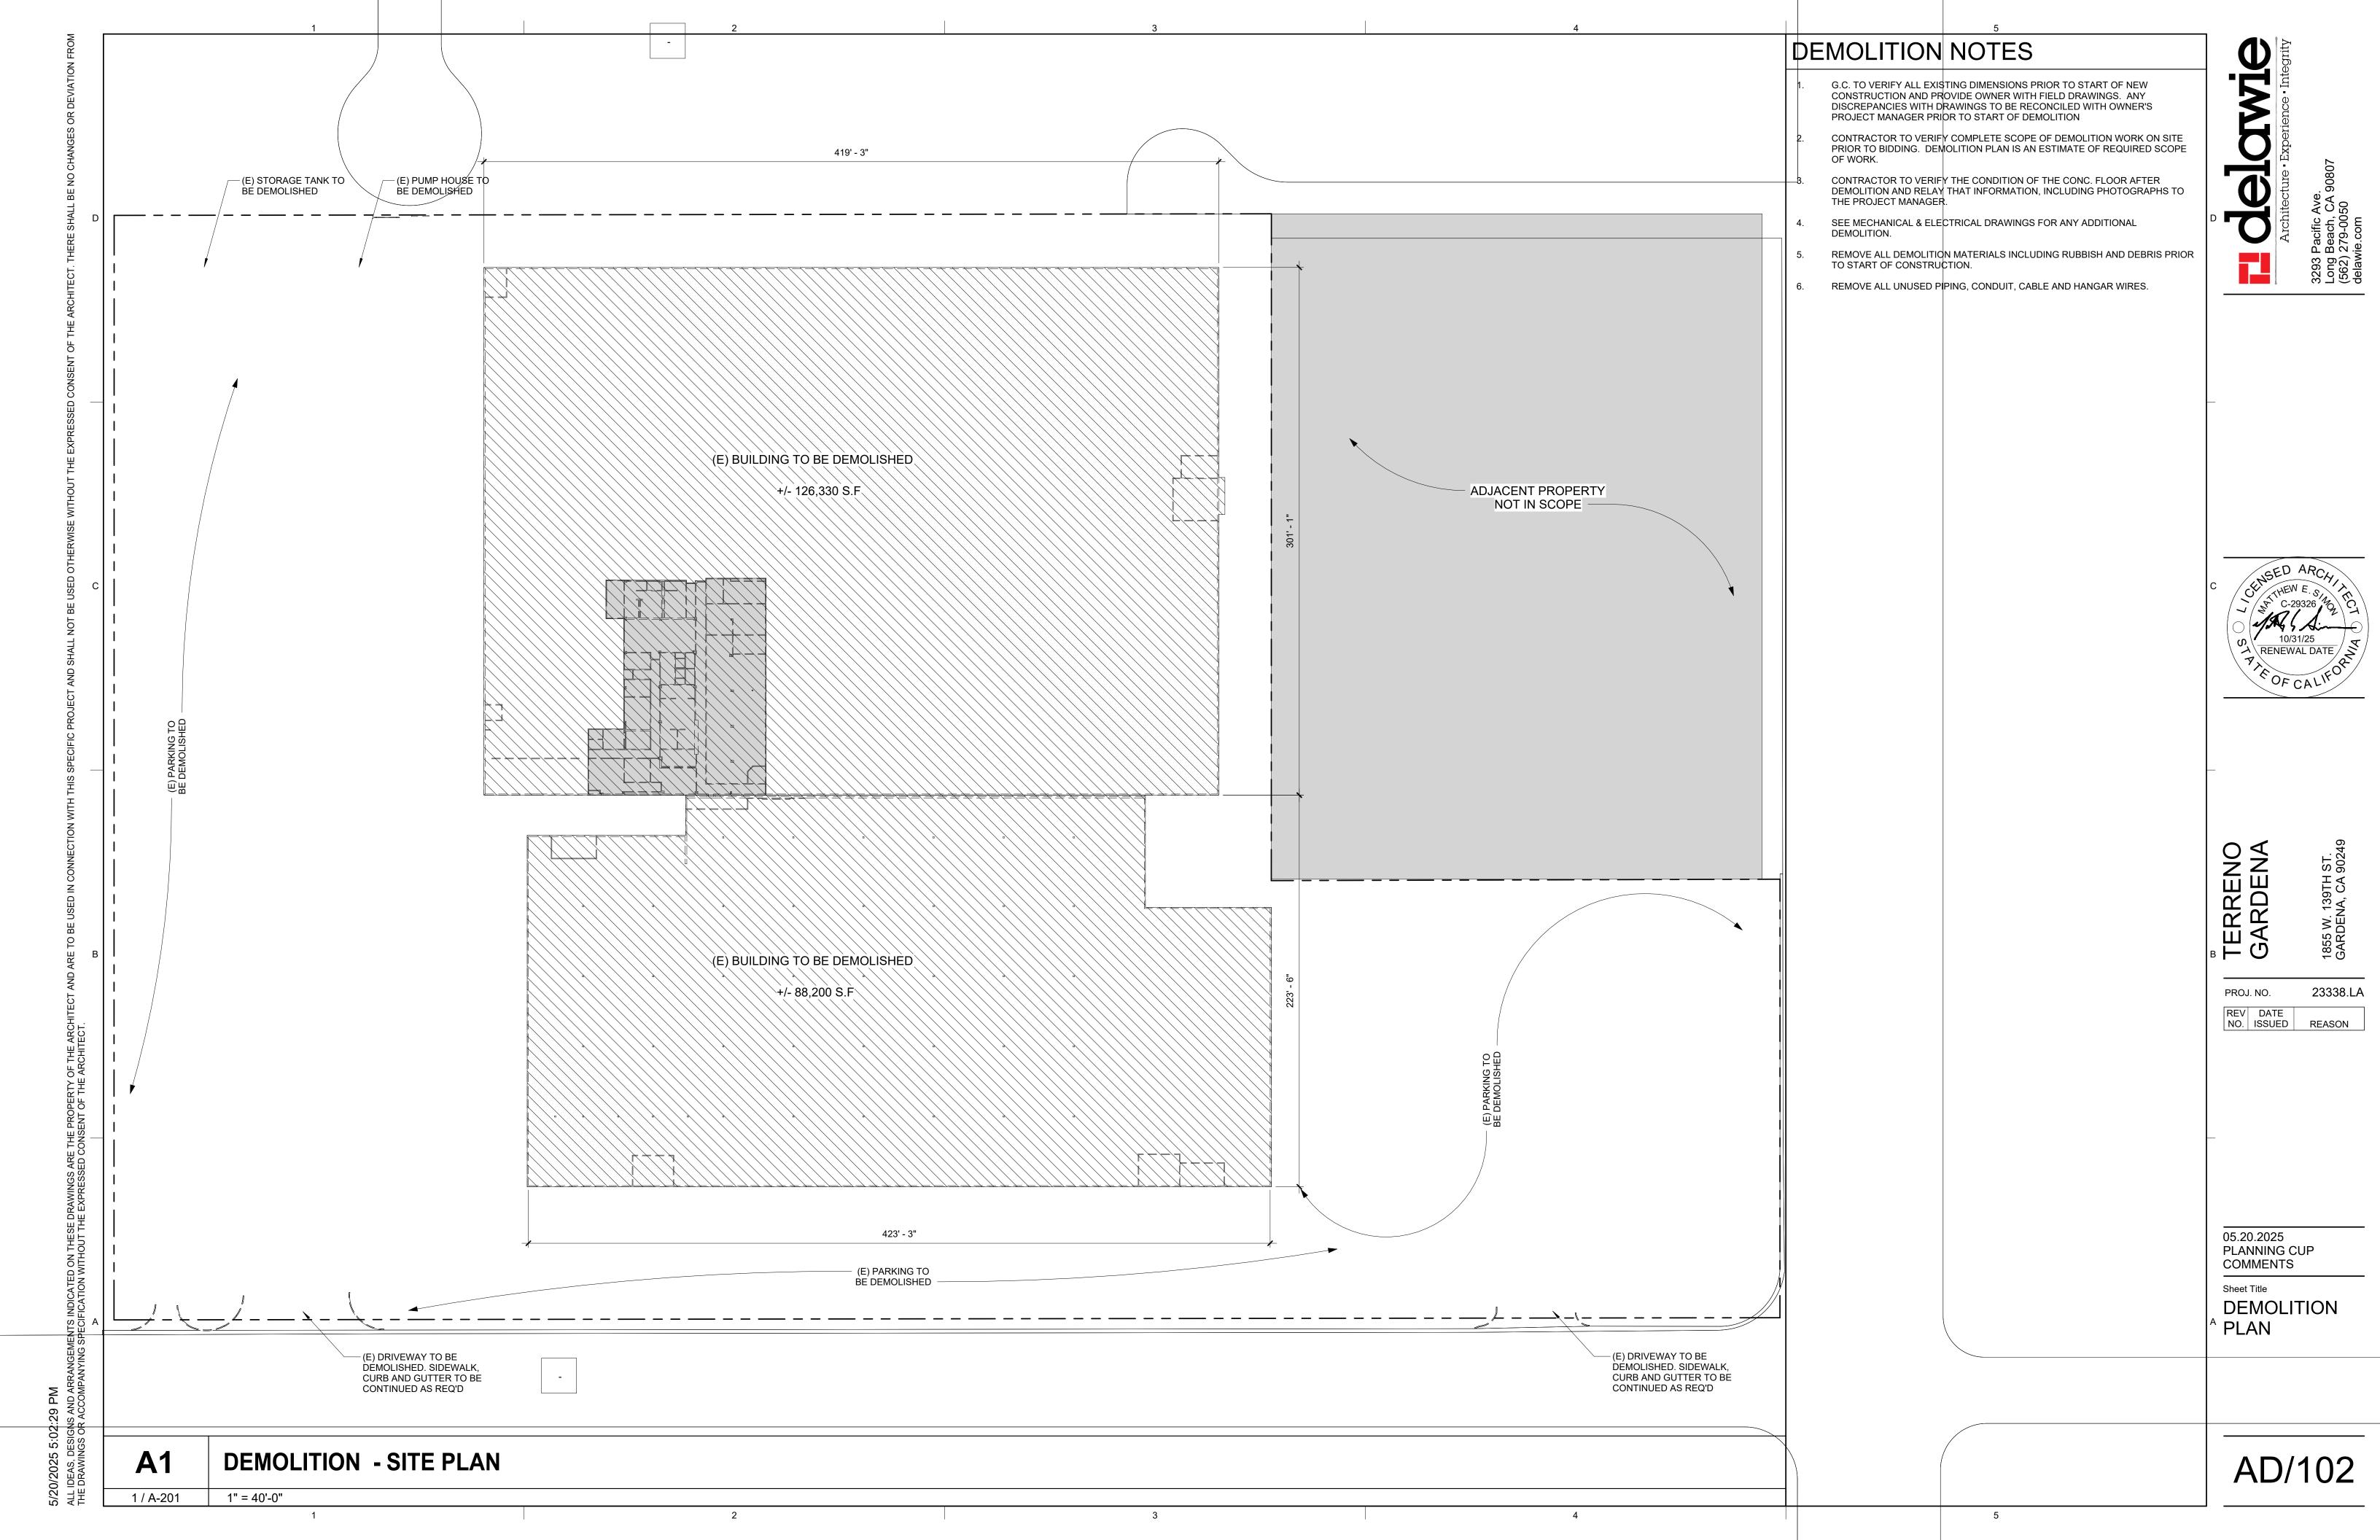


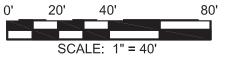



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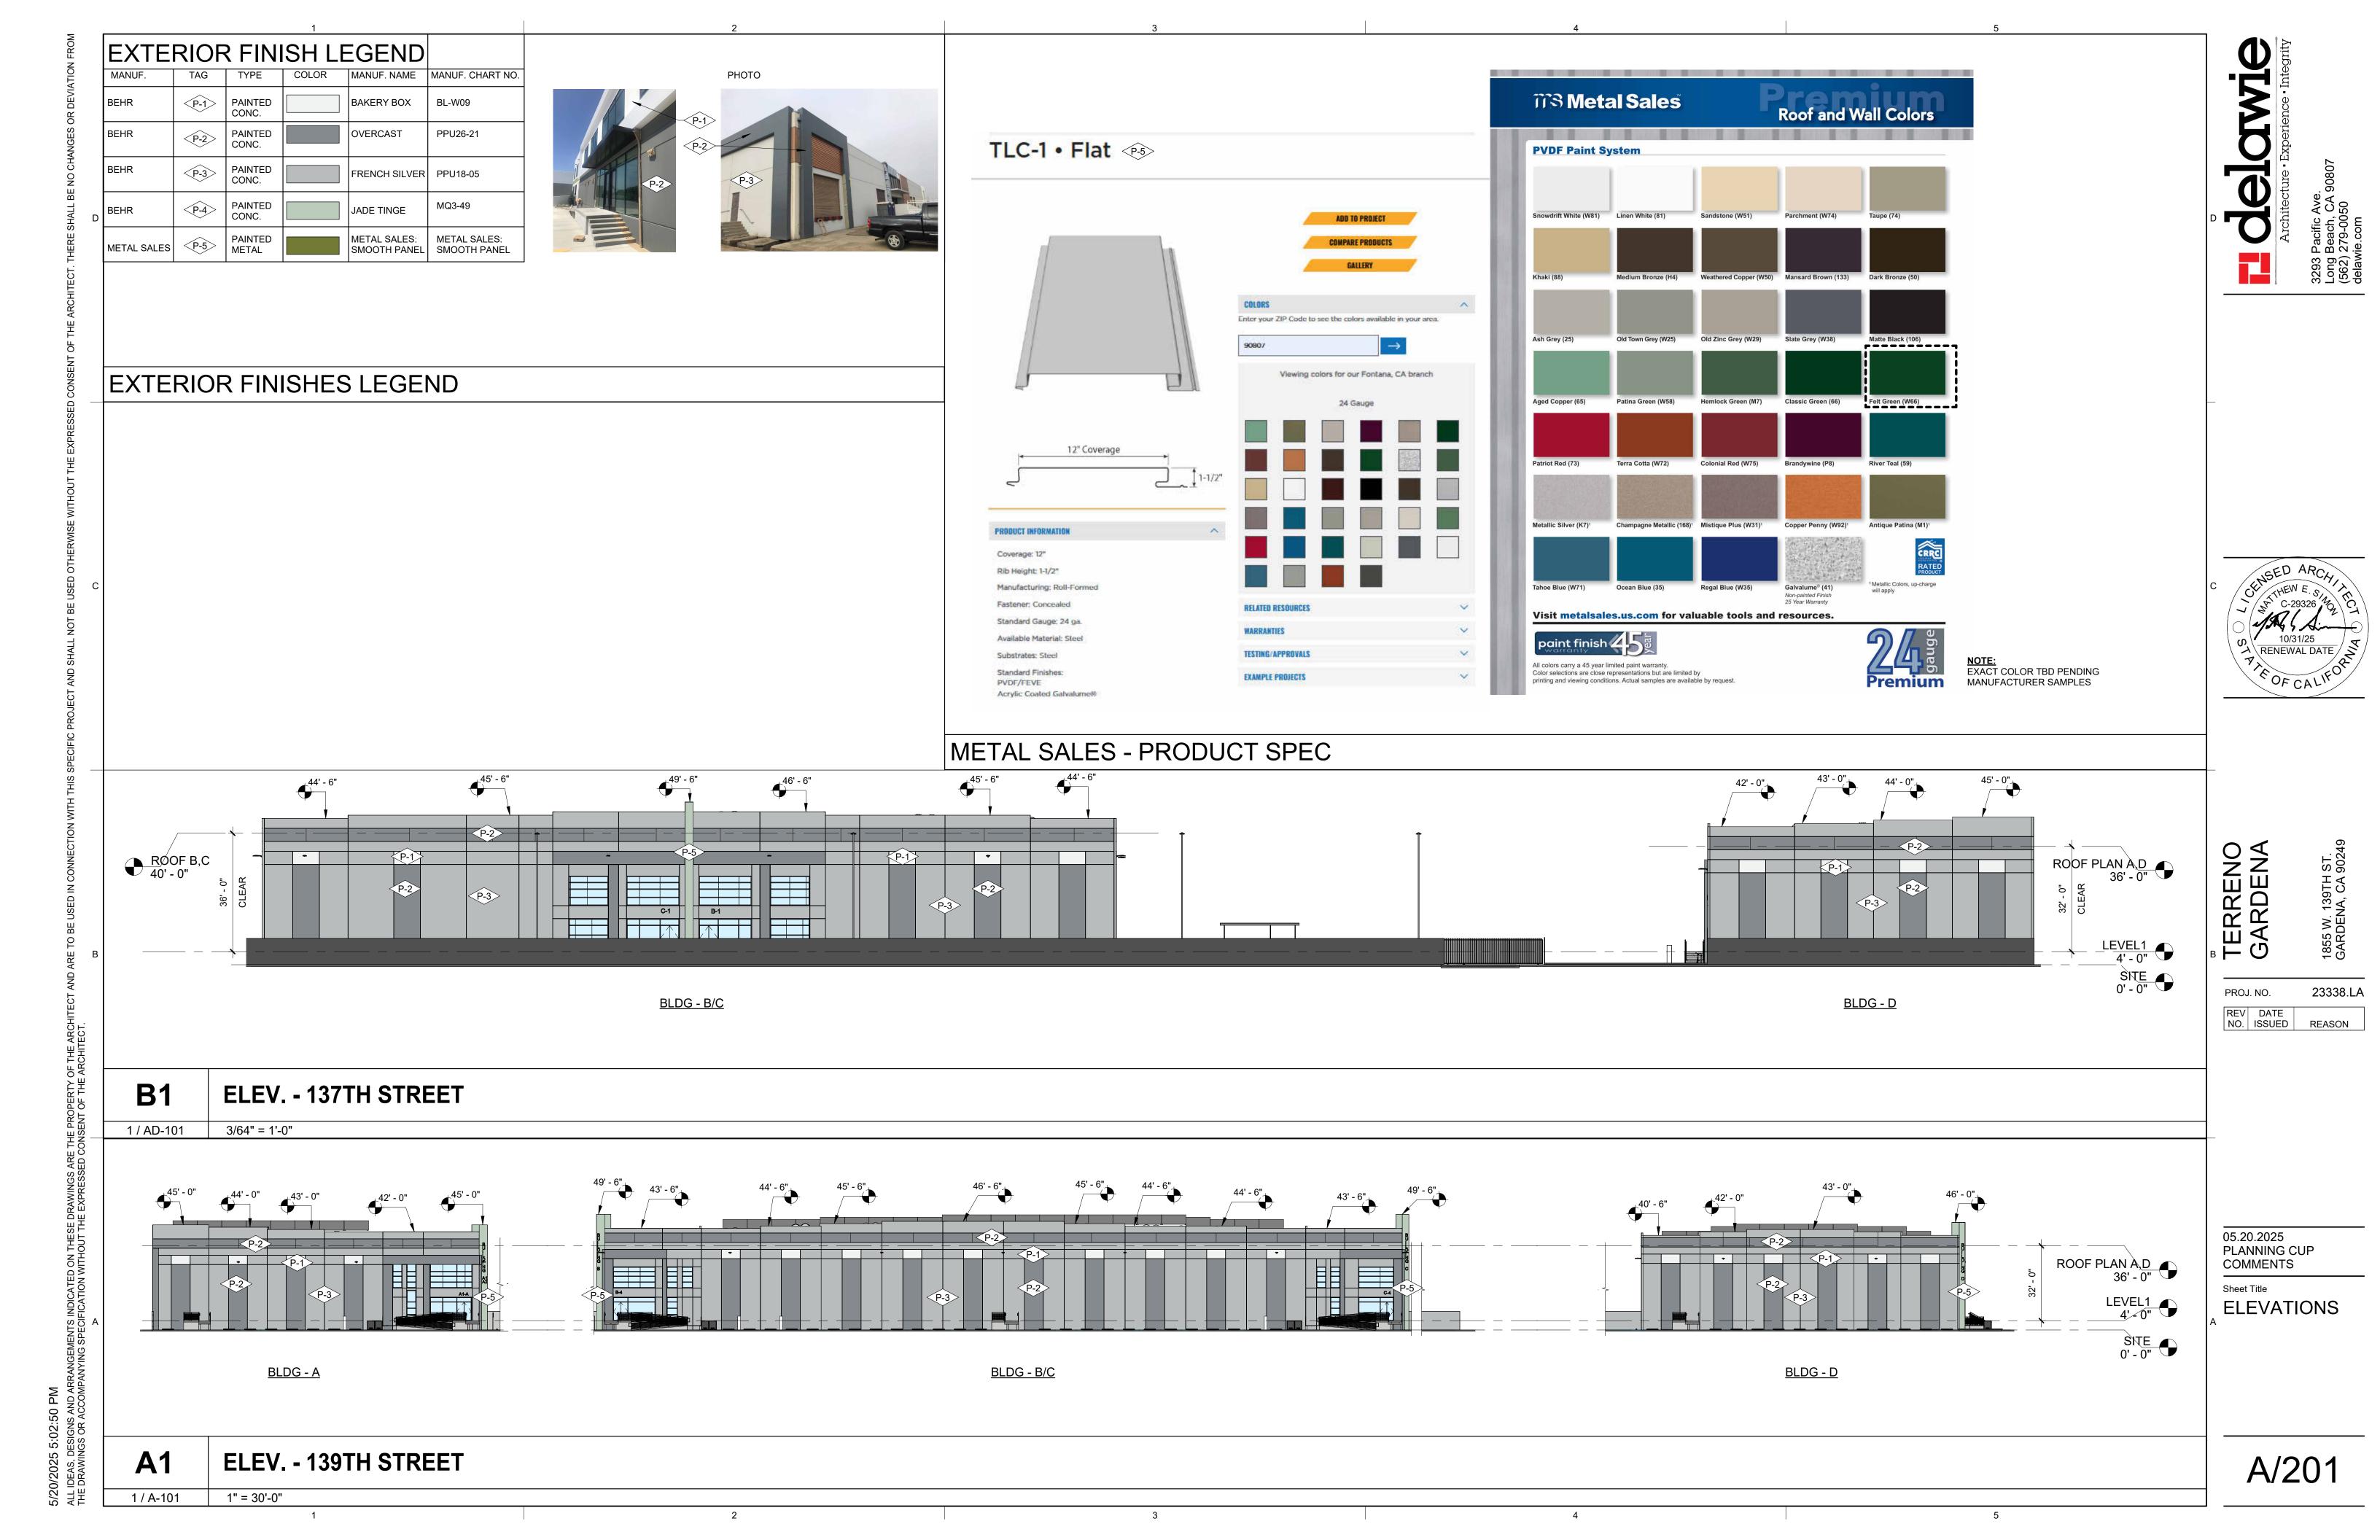


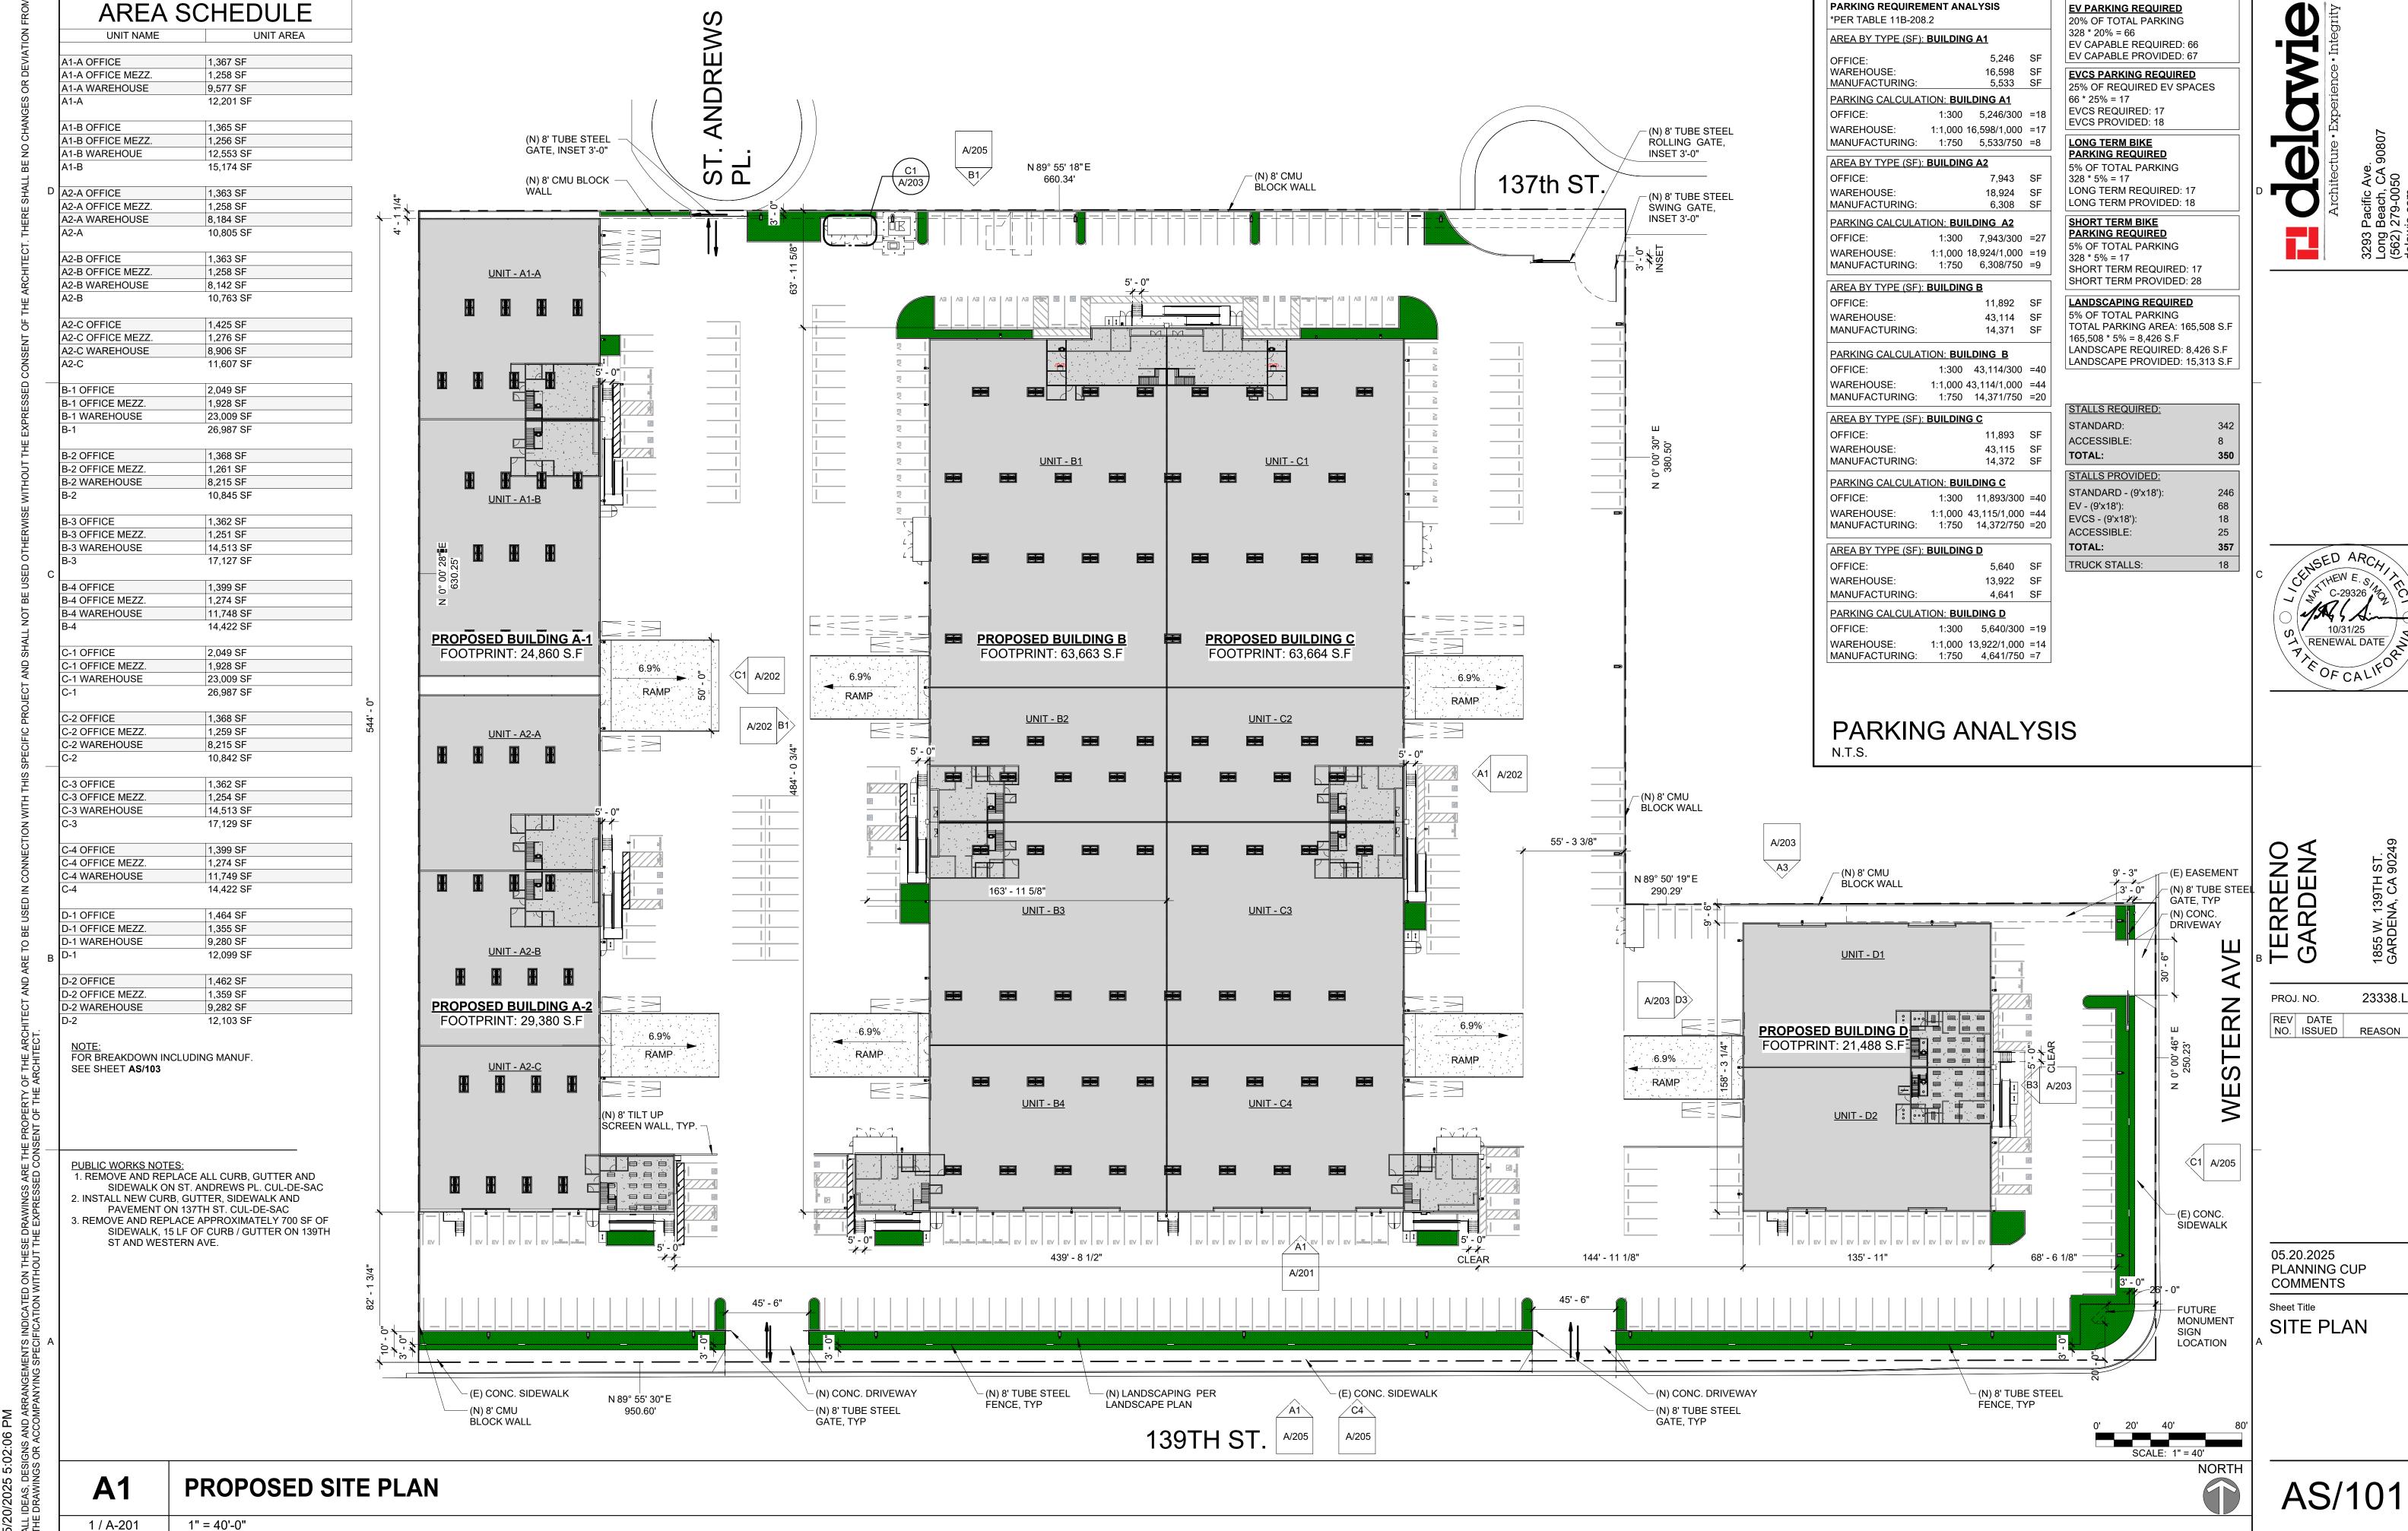





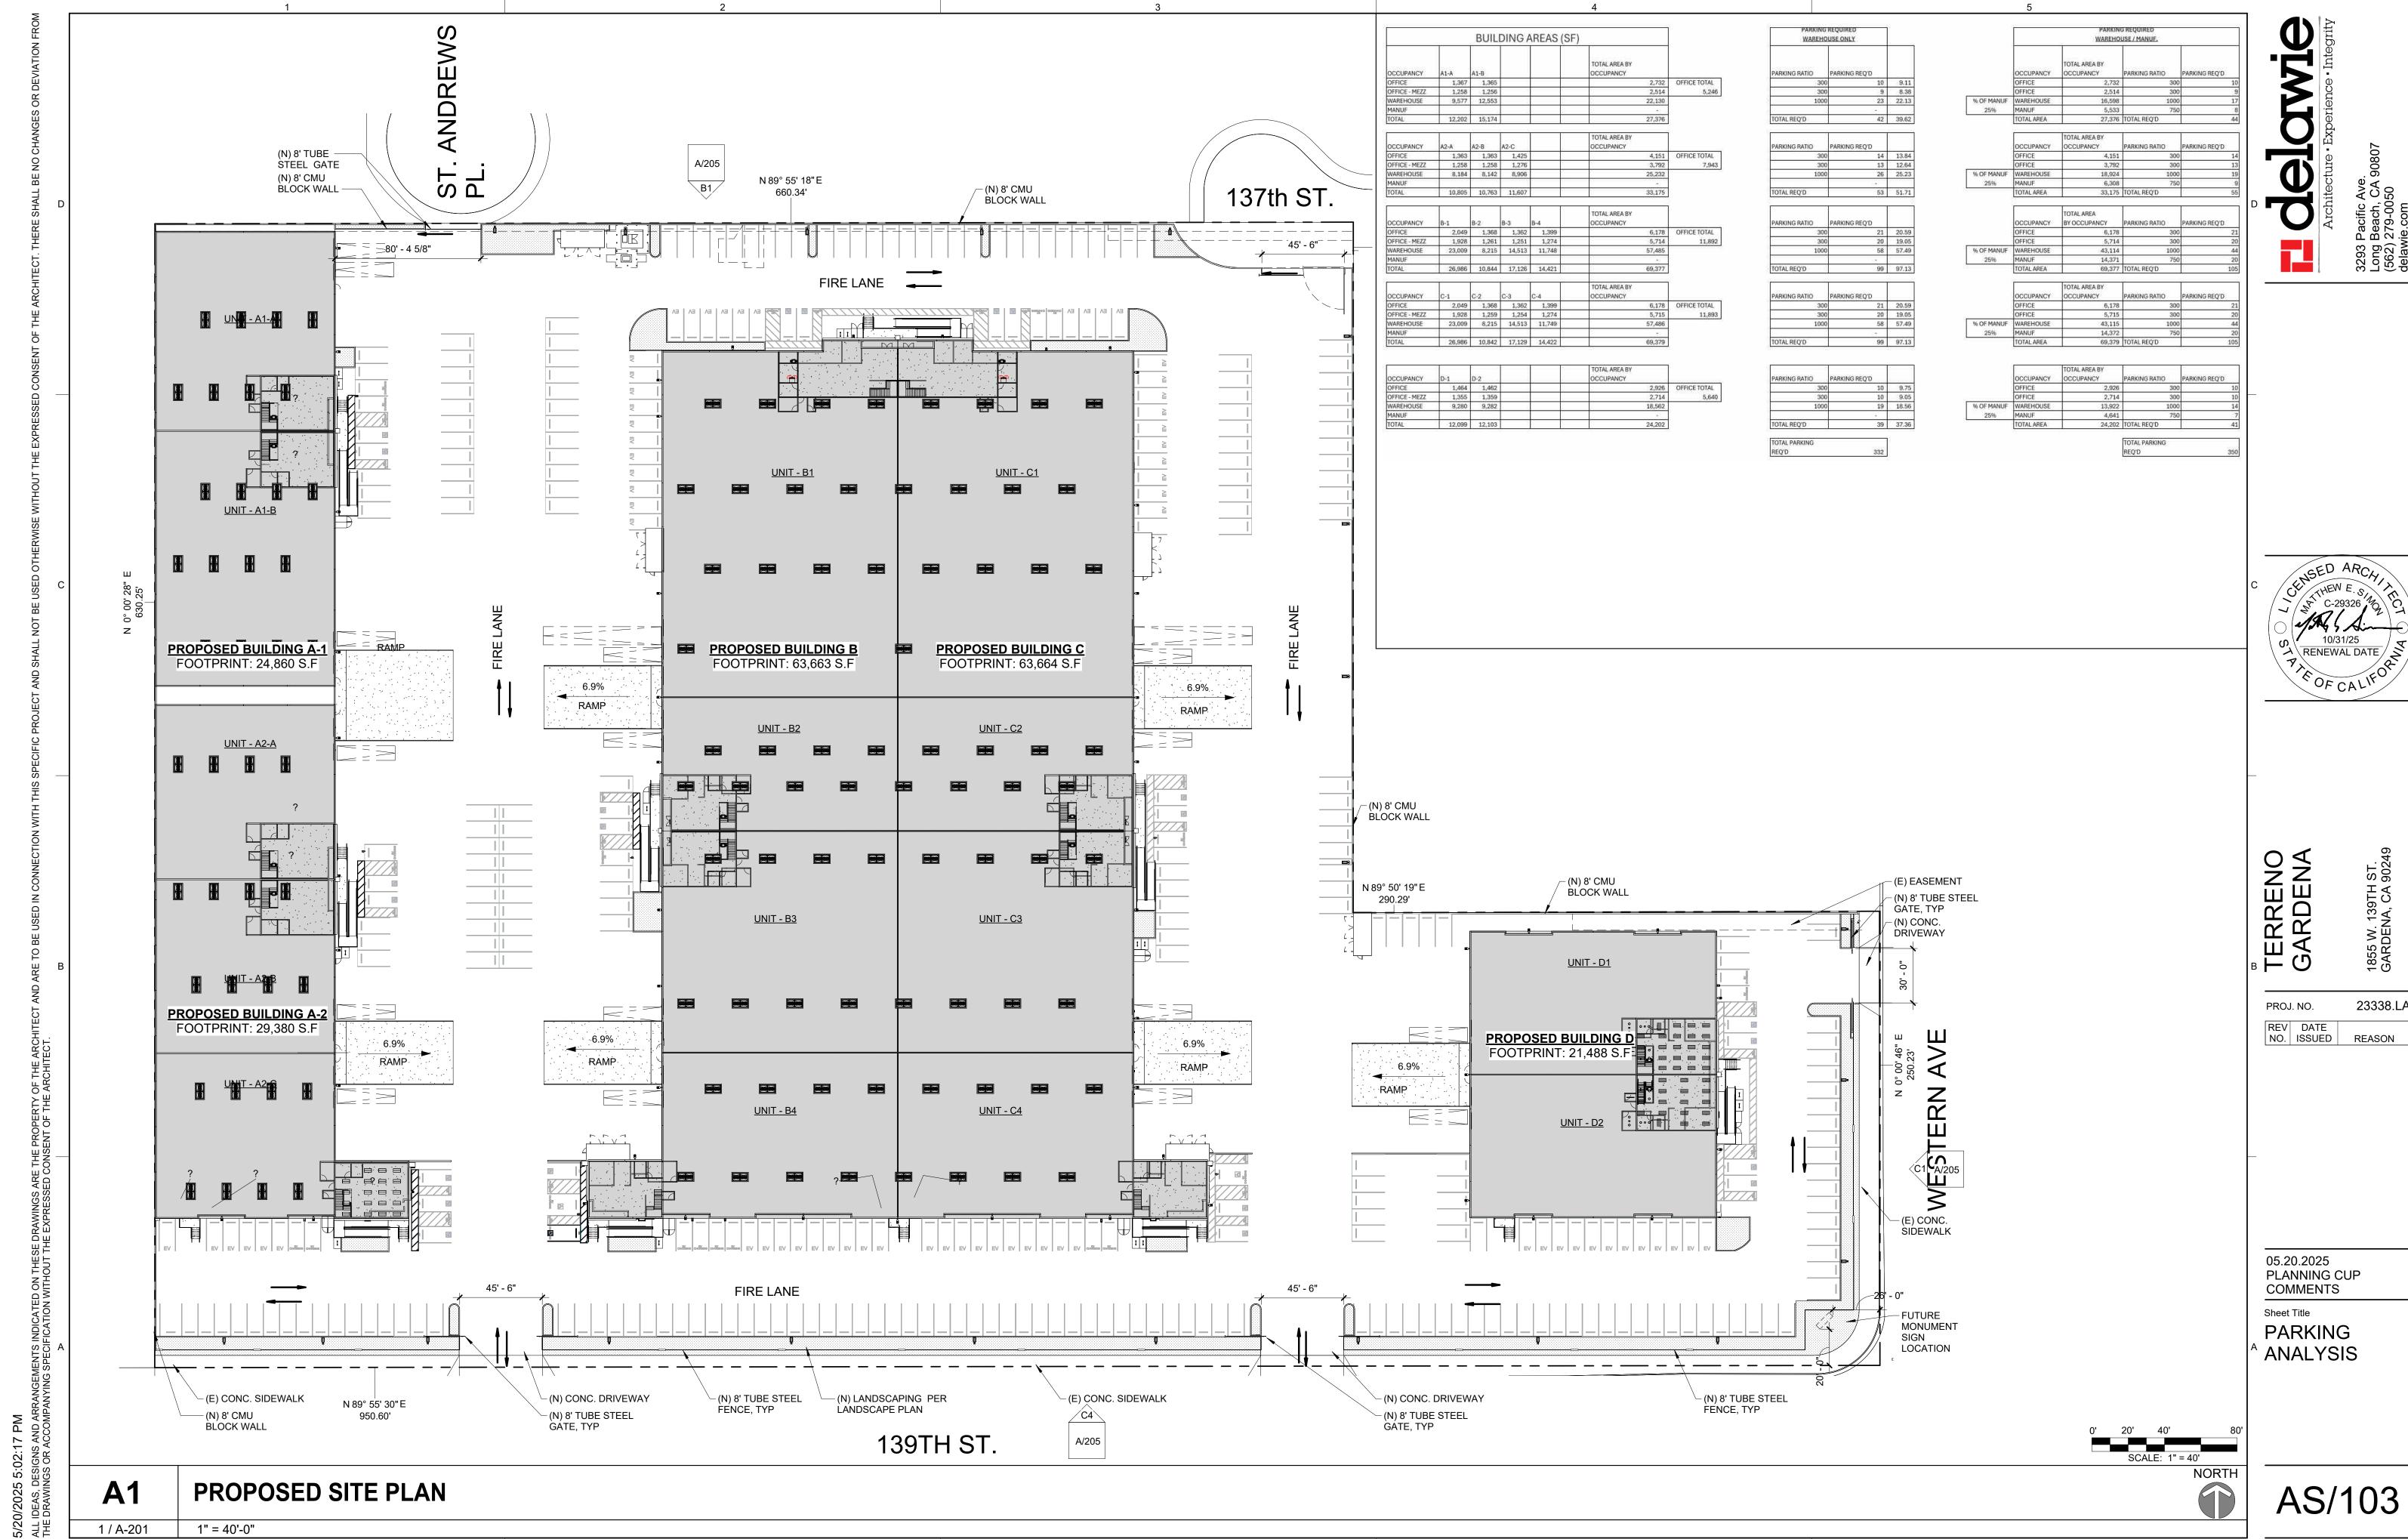

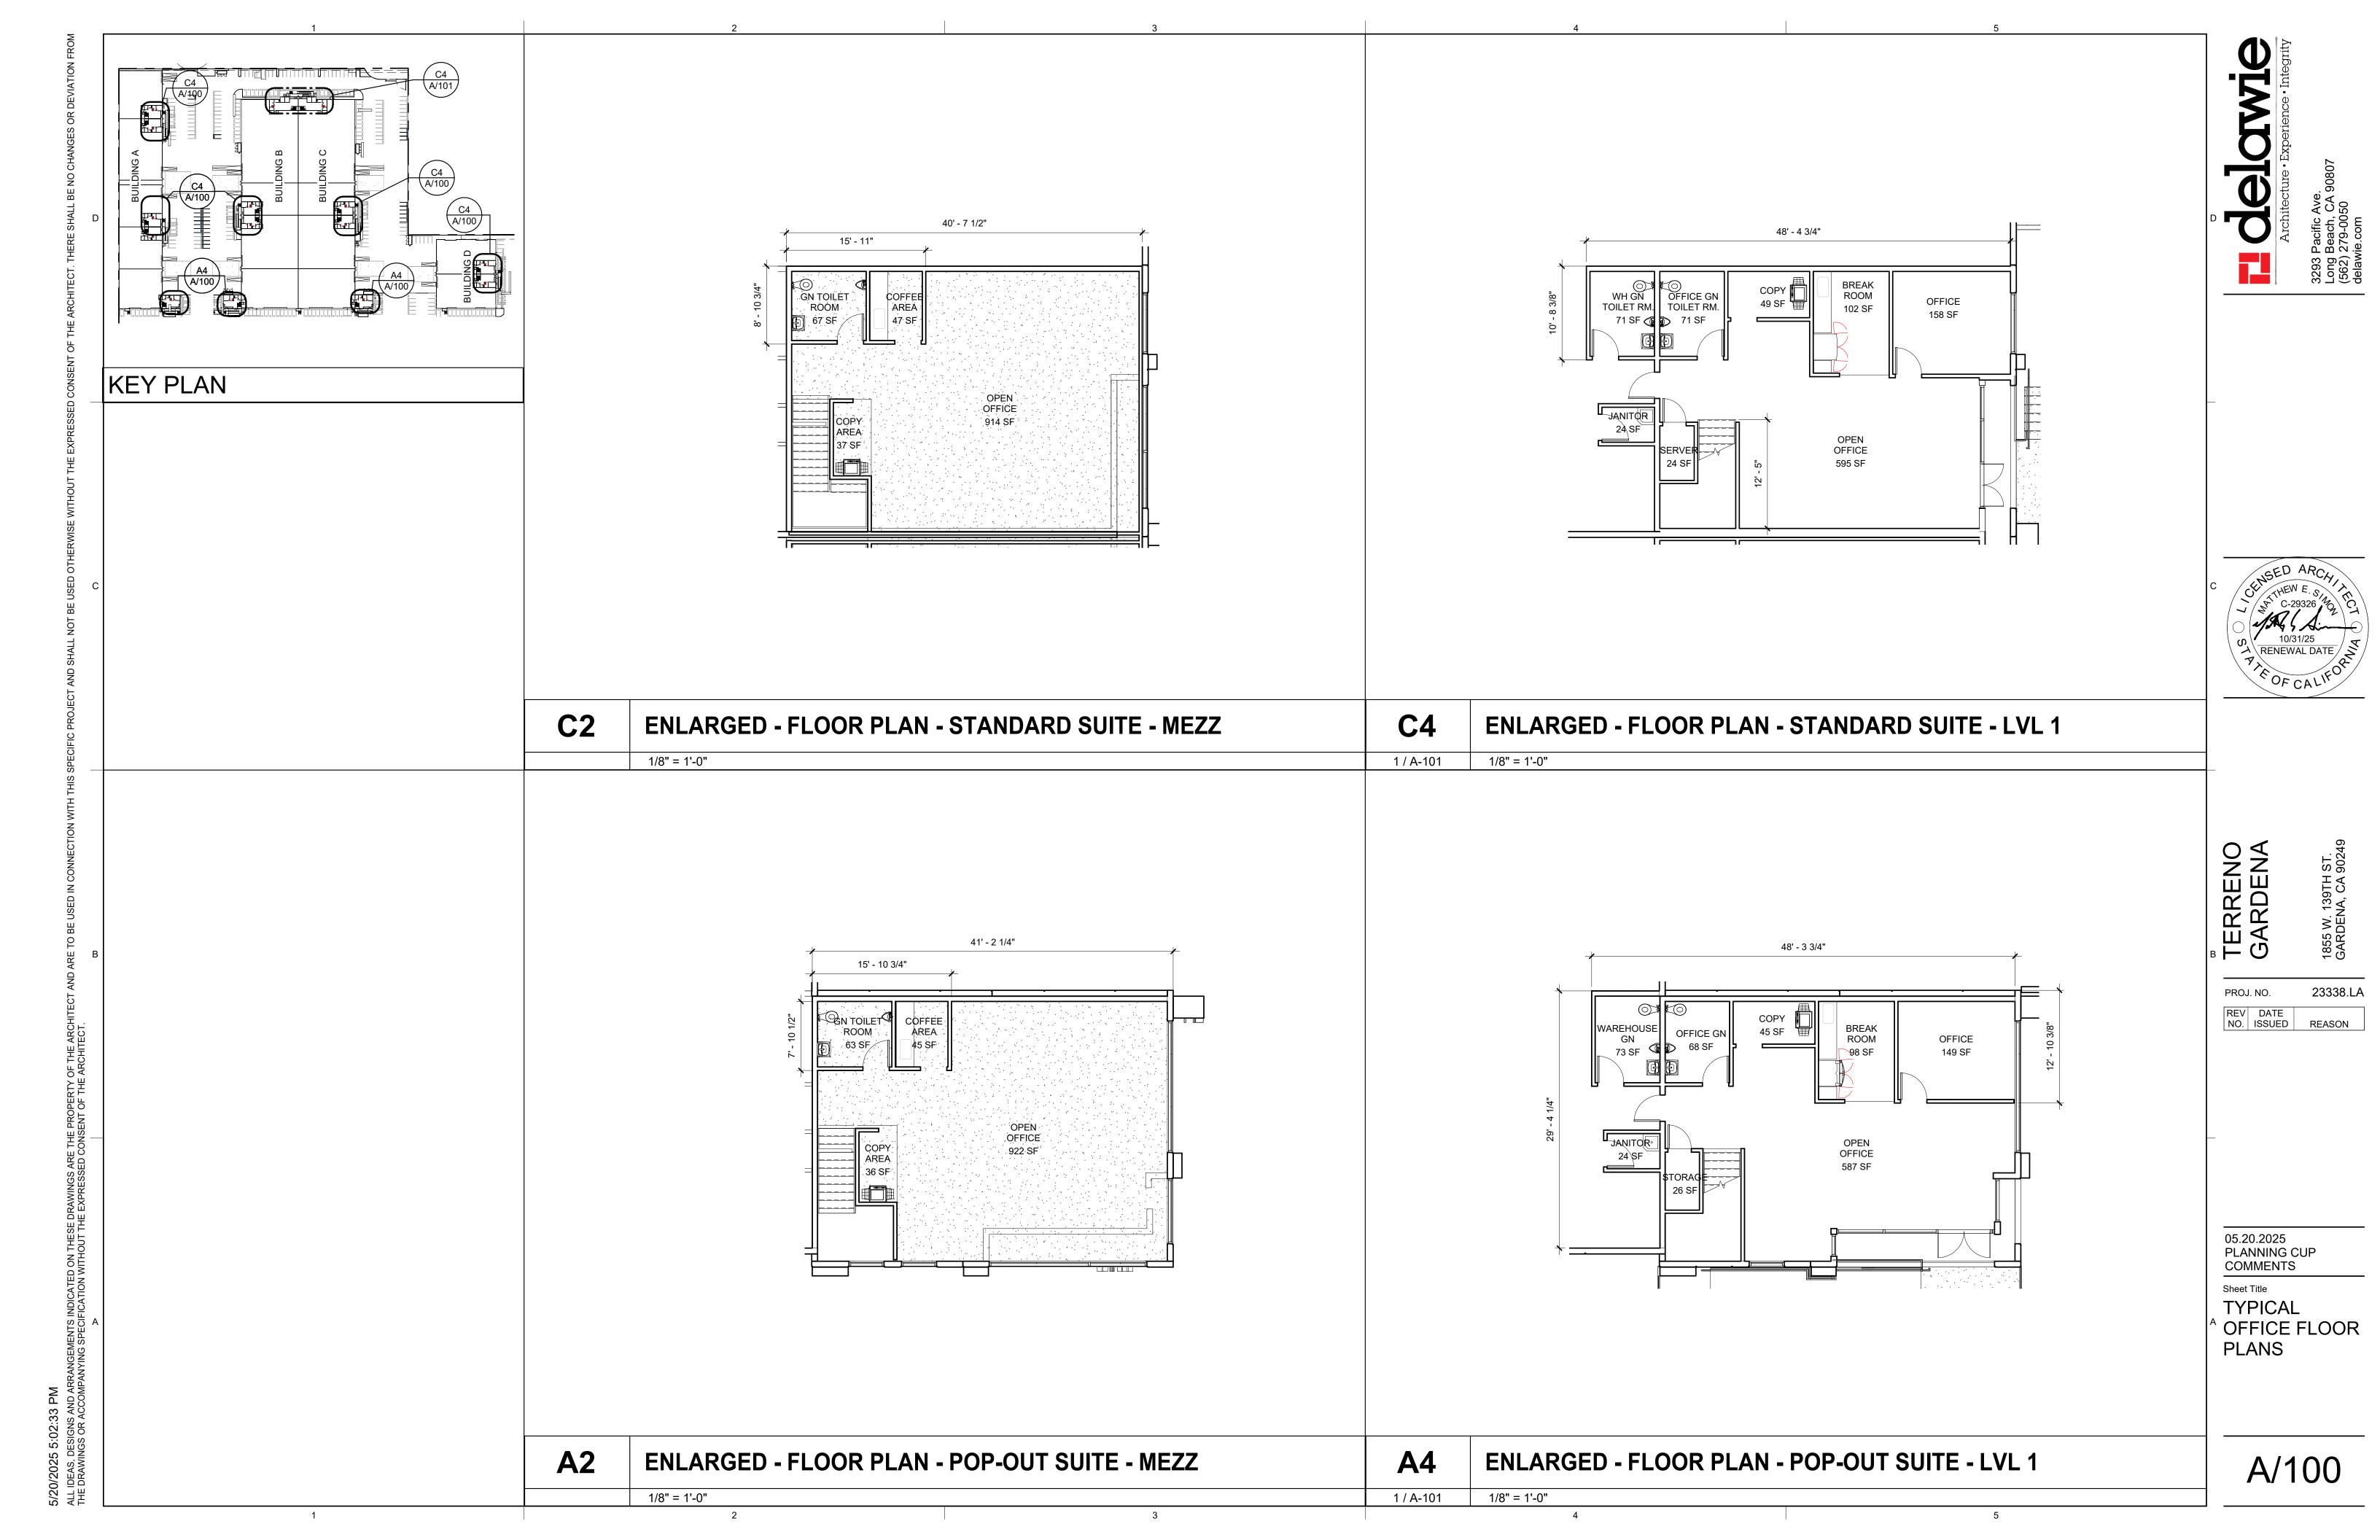

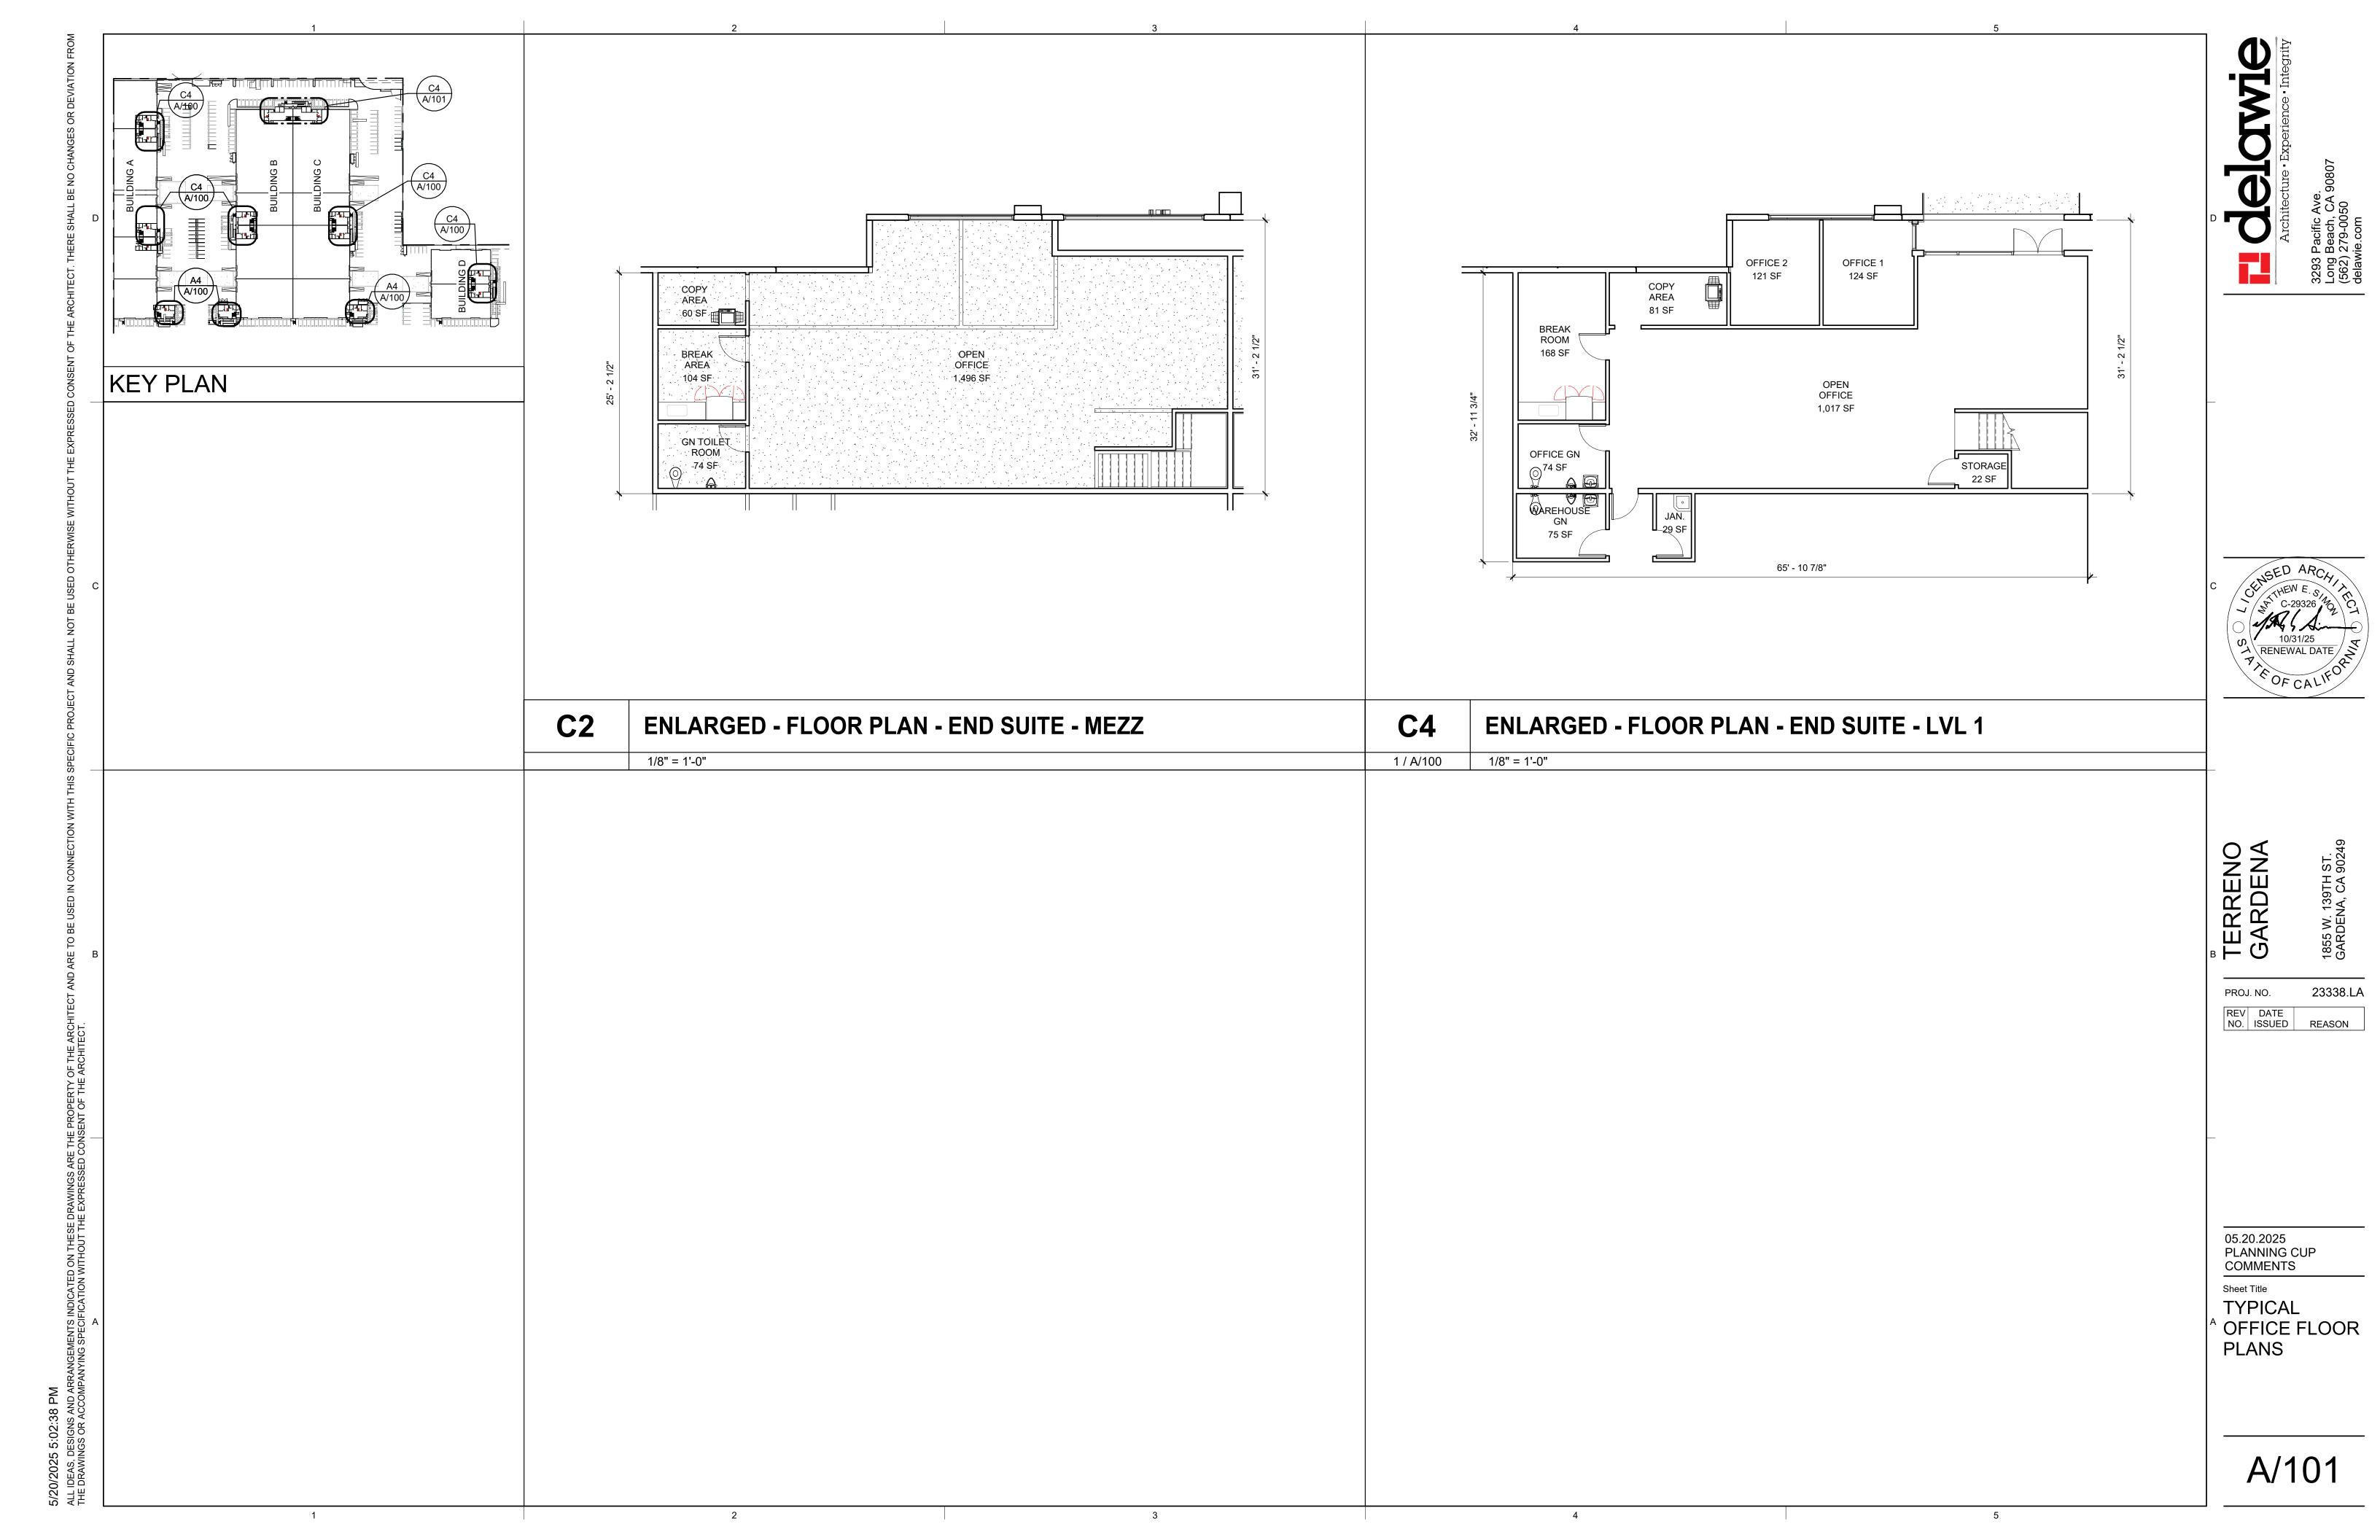

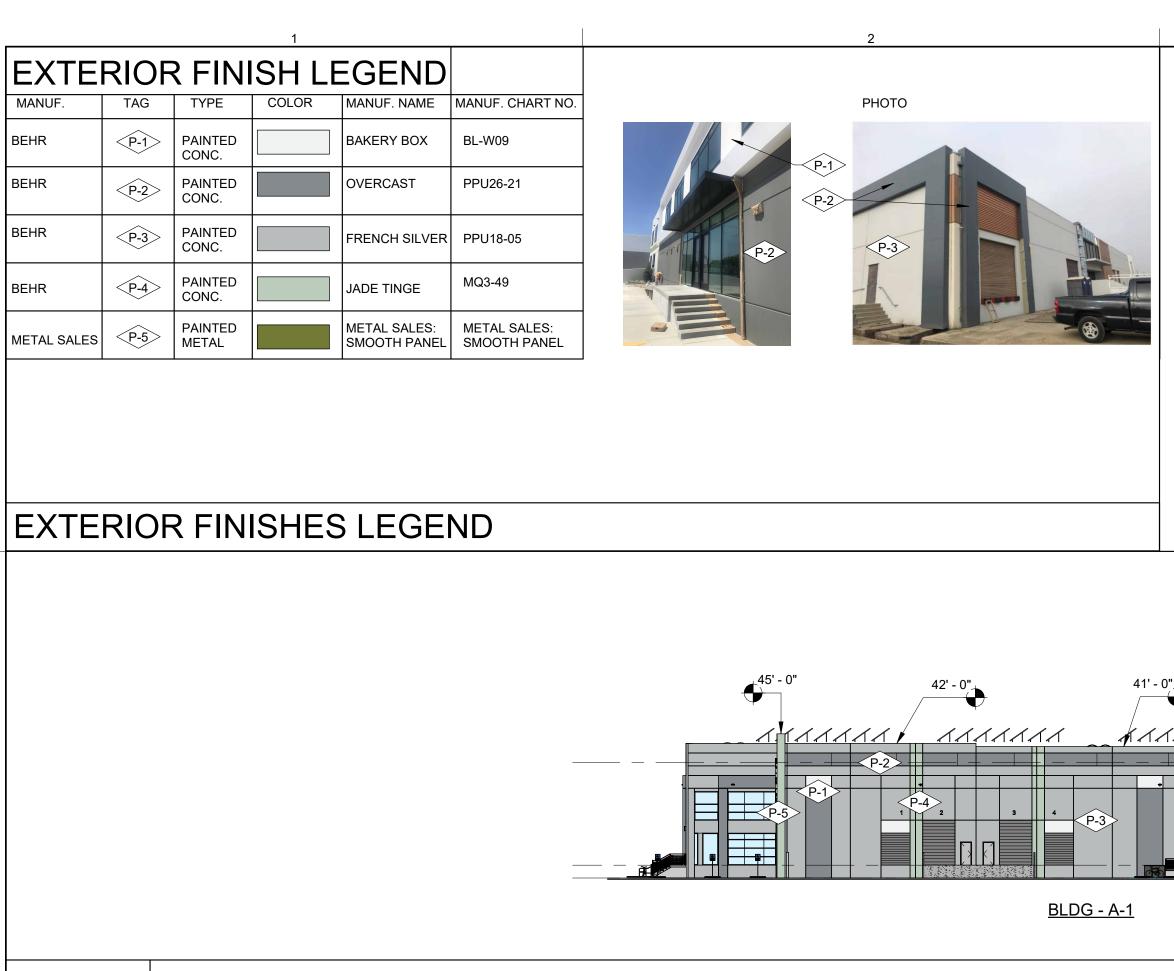

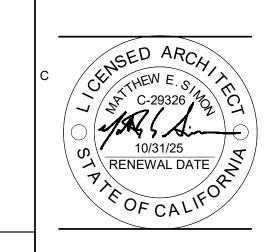

TERREN GARDEI

PROJ. NO.

REV DATE NO. ISSUED REASON

05.20.2025 PLANNING CUP COMMENTS

ELEVATIONS

Sheet Title

23338.LA

ROOF PLAN A,D 36' 0"

<u>BLDG - A-2</u>

LEVEL1 ____4' - 0"

ELEV. 1 - BLDG A C1


1" = 30'-0"

1 / AD-101

ROOF B C 40' - 0" LEVEL1 4' - 0" SNE 0' - 0"

BLDG - B

ELEV. 1 - BLDG B **B1** 1 / AD-101 1" = 30'-0"

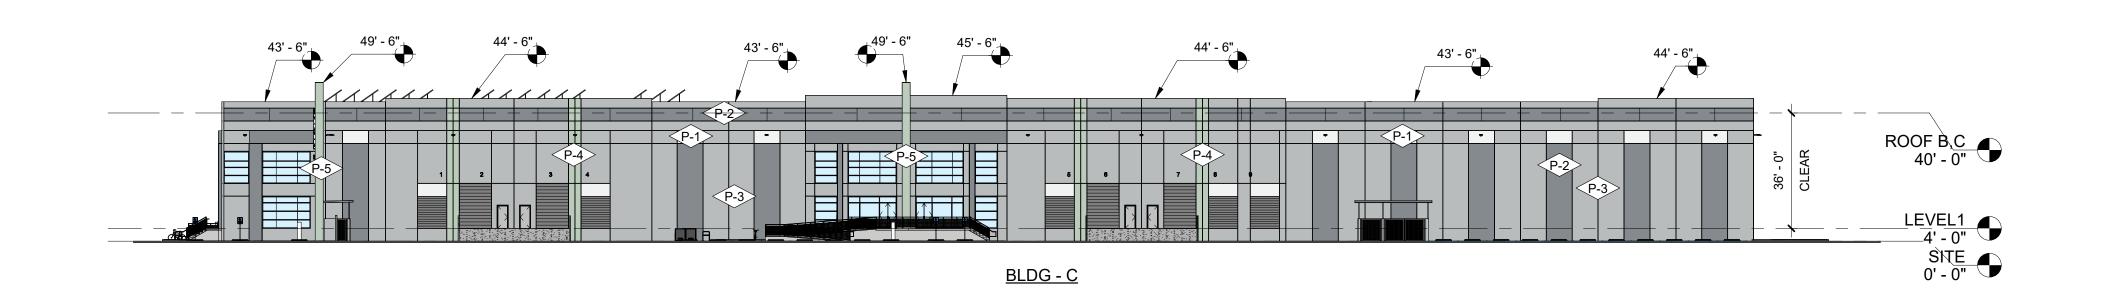



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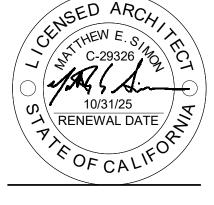
A/202

1 / AD-101






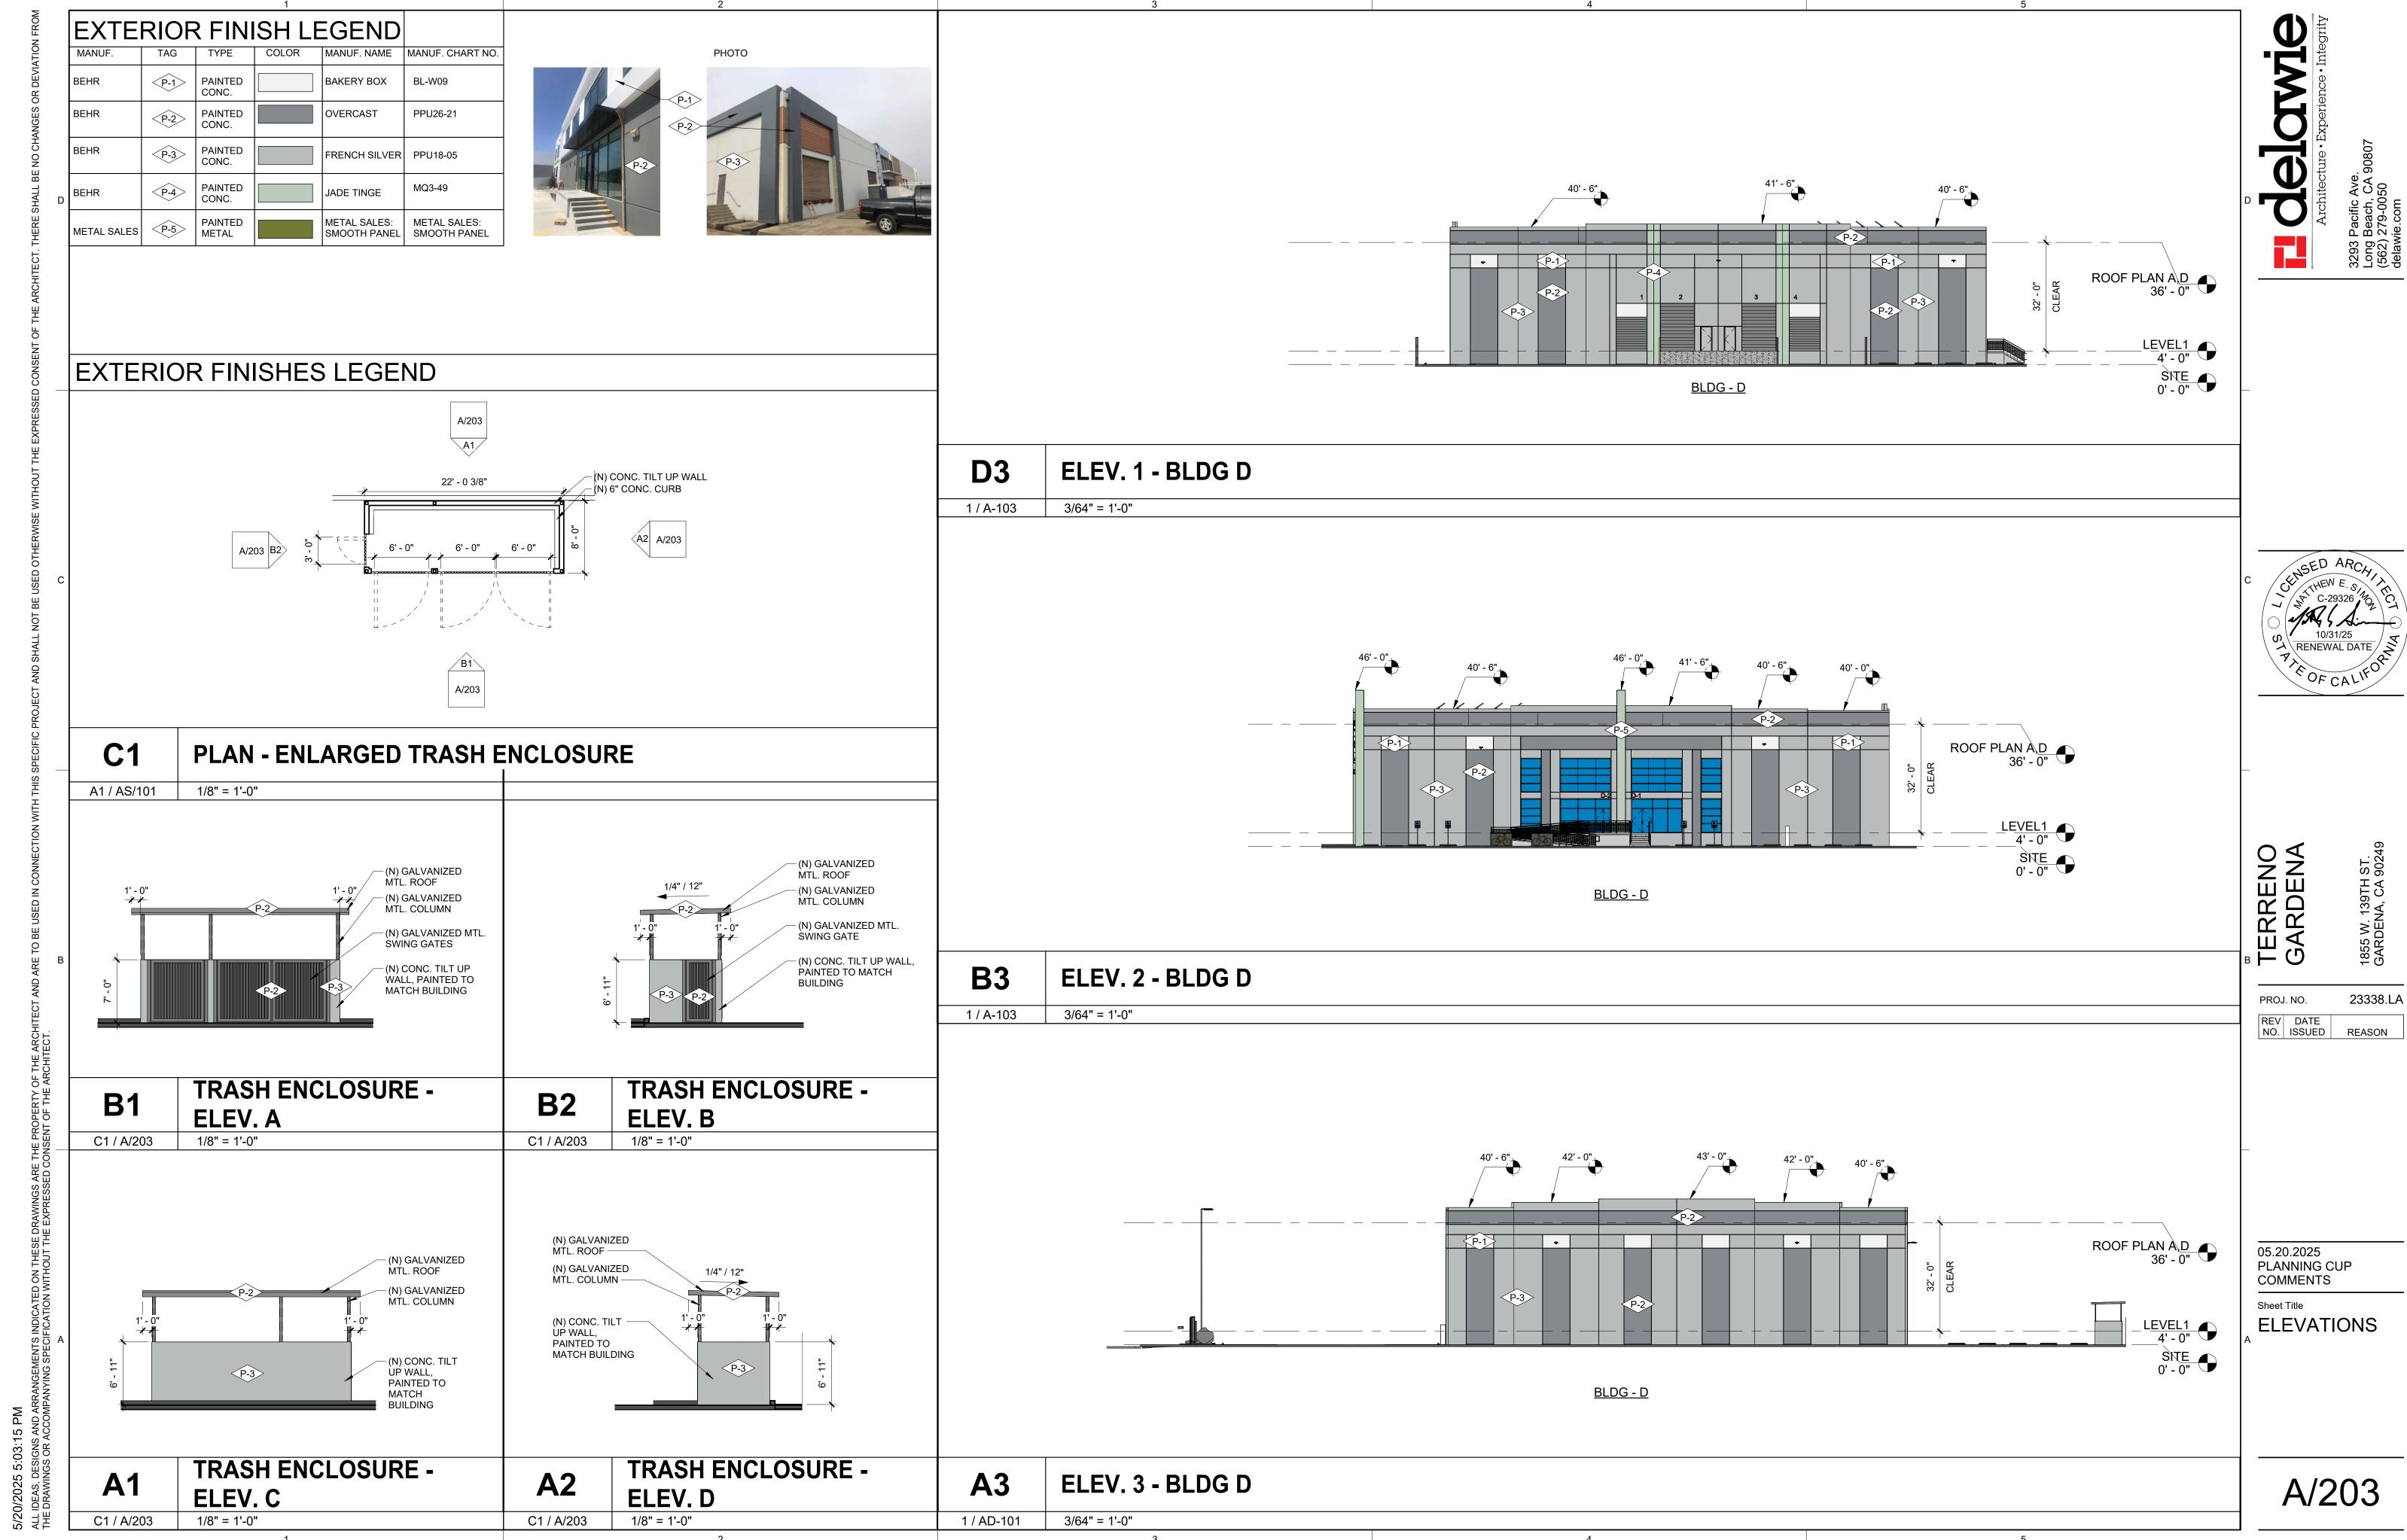

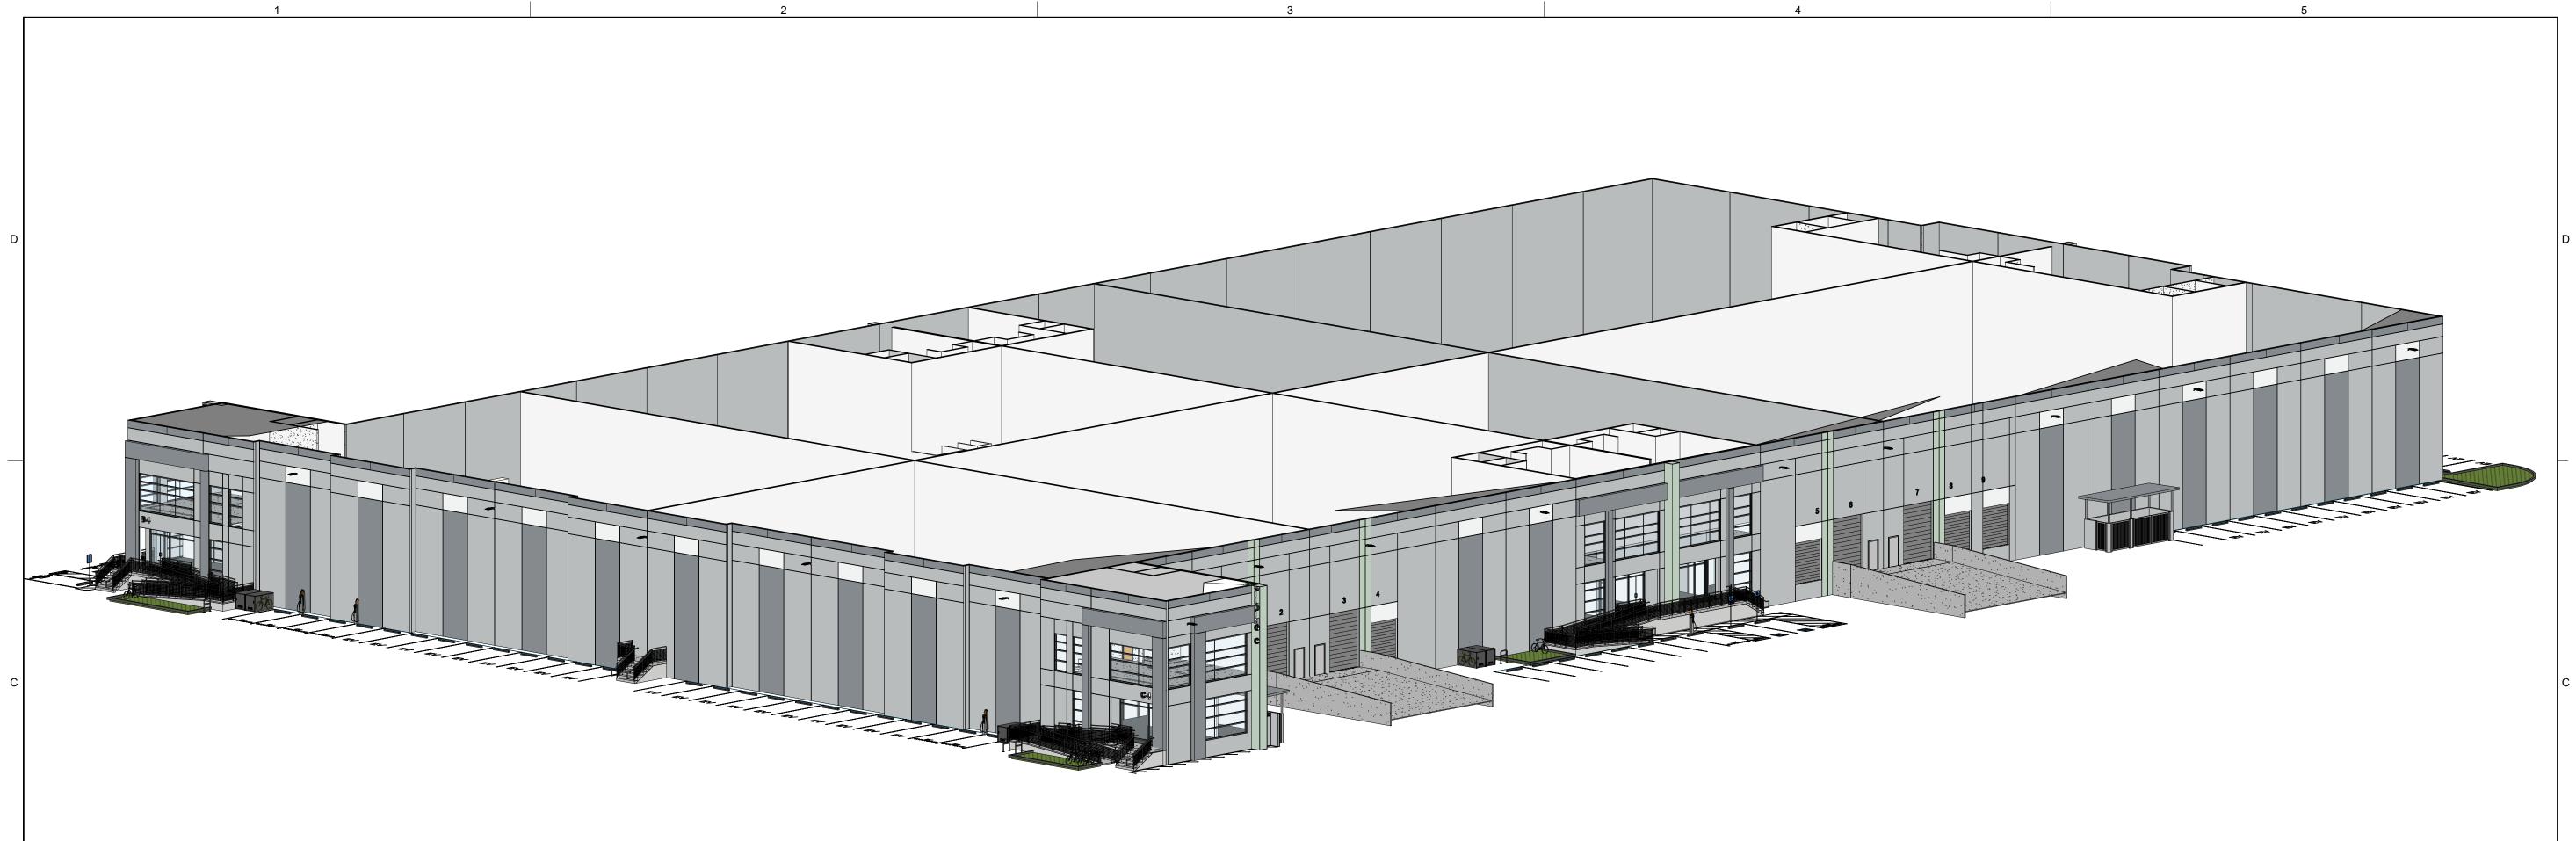

C1 3D VIEW - BLDG B-1

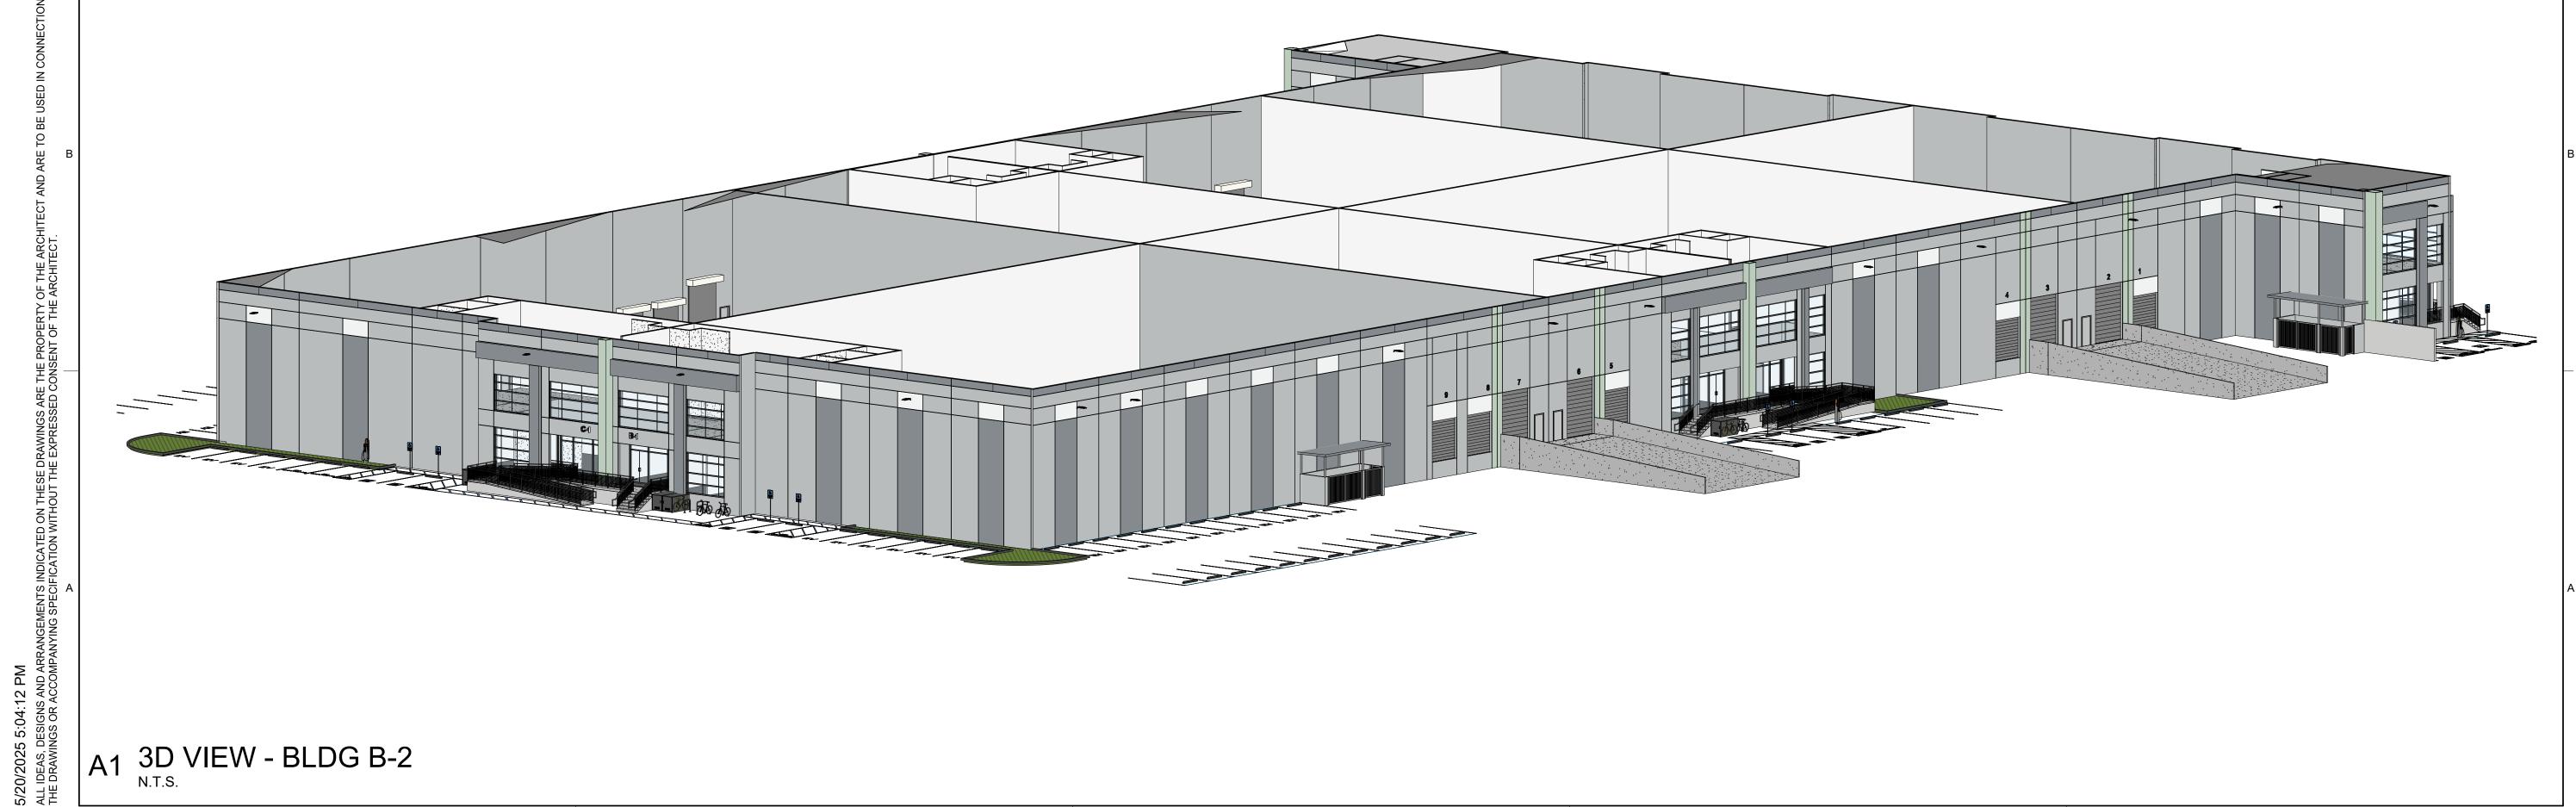

TERRENO GARDENA


23338.LA PROJ. NO. REV DATE NO. ISSUED REASON

05.20.2025 PLANNING CUP COMMENTS

Sheet Title
3D VIEWS

A1 3D VIEW - BLDG B-2

A/204

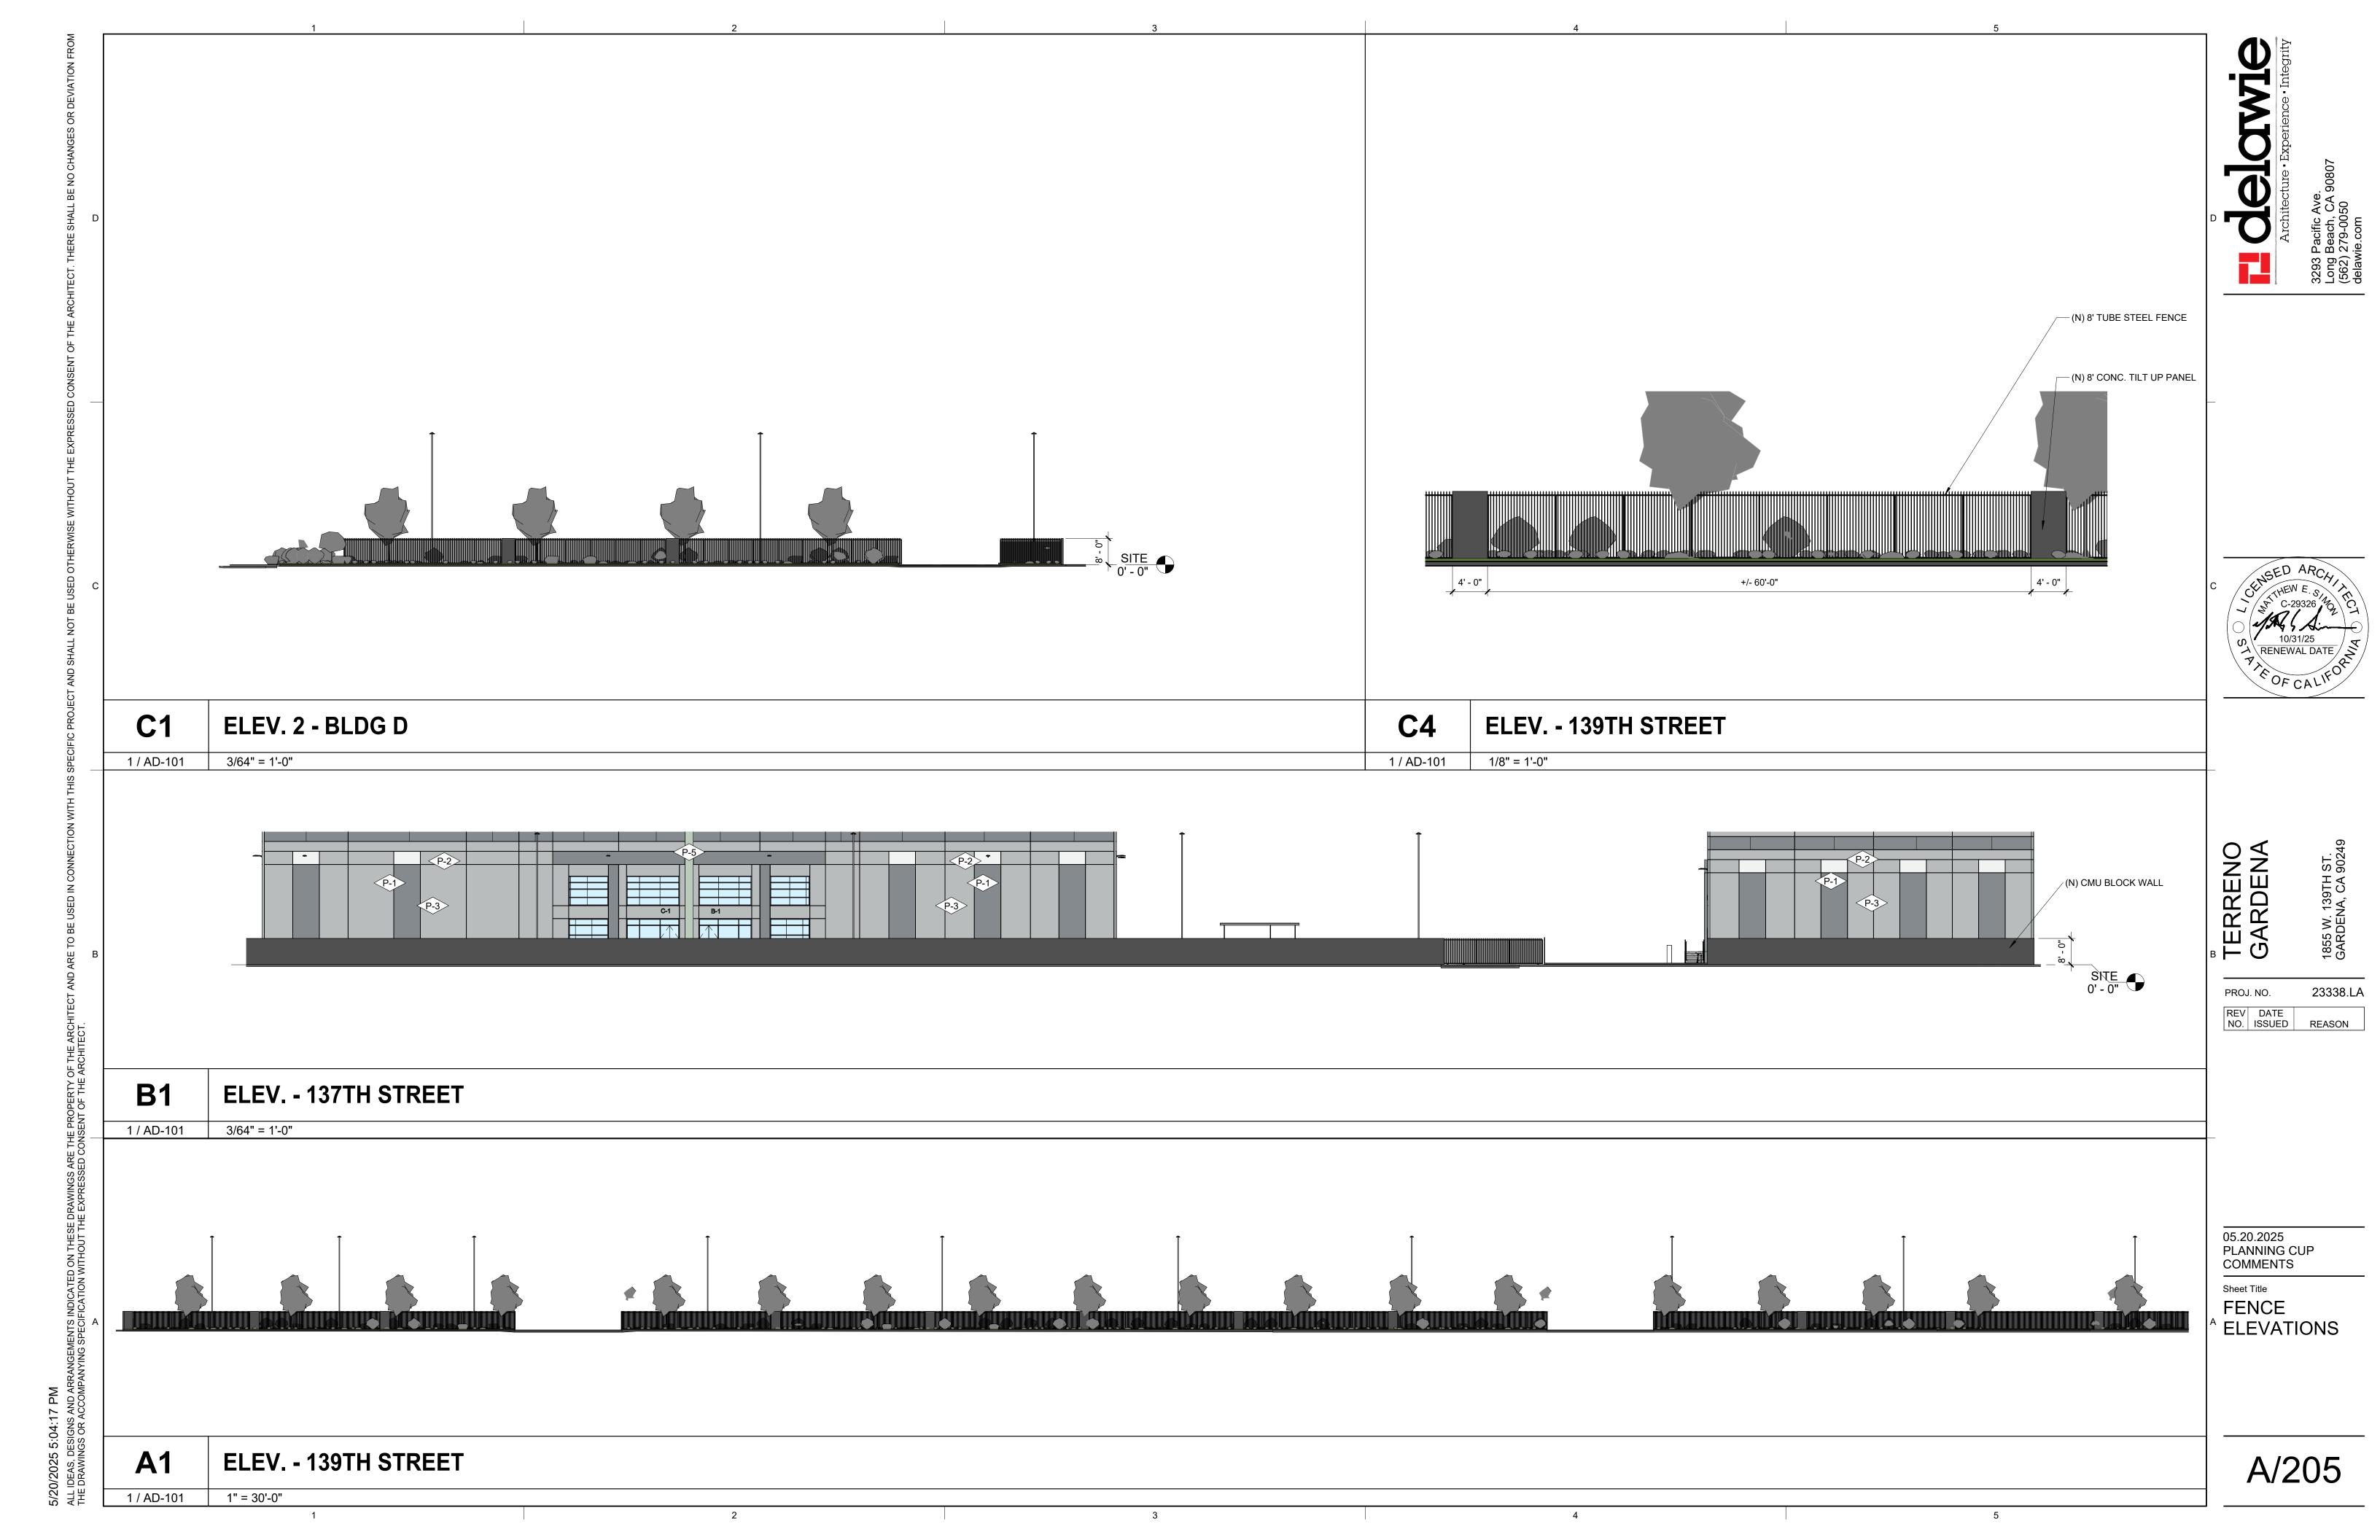

DIVISION 16 - ELECTRICAL

SECTION 16000

BASIC ELECTRICAL REQUIREMENTS

- 1. DRAWINGS AND GENERAL PROVISIONS OF CONTRACT, INCLUDING GENERAL AND SUPPLEMENTARY CONDITIONS AND ALL OTHER SPECIFICATION SECTIONS, APPLY TO THIS AND THE OTHER SECTIONS OF DIVISION 16.
- 2. THE CONTRACTOR FOR THIS DIVISION OF WORK IS REQUIRED TO READ THE SPECIFICATIONS AND REVIEW DRAWINGS FOR ALL DIVISIONS OF WORK AND IS RESPONSIBLE FOR THE COORDINATION OF THIS WORK AND THE WORK OF HIS SUBCONTRACTORS WITH ALL DIVISIONS OF WORK. IT IS THIS CONTRACTORS RESPONSIBILITY TO PROVIDE HIS SUBCONTRACTORS WITH A COMPLETE SET OF BID DOCUMENTS.
- 3. THIS ELECTRICAL CONTRACTOR IS RESPONSIBLE FOR SCHEDULING THE COMPLETION AND INSPECTION OF THIS WORK TO COMPLY WITH TENANT/ARCHITECT'S SCHEDULE AND THE PROJECT COMPLETION DATE.
- 4. THIS CONTRACTOR SHALL VISIT THE SITE PRIOR TO SUBMITTAL OF BID TO DETERMINE CONDITIONS AFFECTING THE WORK. ANY DISCREPANCIES OR ITEMS WHICH ARE NOT COVERED IN THE BID DOCUMENTS OR ANY PROPOSED SUBSTITUTIONS SHALL BE LISTED SEPARATELY AND QUALIFIED IN THE CONTRACTORS BID. SUBMITTAL OF BID. SHALL SERVE AS EVIDENCE OF KNOWLEDGE OF EXISTING CONDITIONS AND ANY MODIFICATIONS WHICH ARE REQUIRED TO MEET THE INTENT OF THE DRAWINGS AND SPECIFICATIONS. FAILURE TO VISIT THE SITE DOES NOT RELIEVE THE CONTRACTOR OF RESPONSIBILITY IN PERFORMANCE OF HIS WORK.
- 5. REFER TO RESPONSIBILITY SCHEDULE FOR INFORMATION IN REGARD TO RESPONSIBILITY OF WORK OR ITEMS WHICH MAY AFFECT THE BID.

B. GENERAL REQUIREMENTS

- 1. THIS CONTRACTOR SHALL PROVIDE ALL LABOR, MATERIALS, EQUIPMENT, SERVICES, TOOLS, TRANSPORTATION, INCIDENTALS AND DETAILS NECESSARY TO PROVIDE A COMPLETE ELECTRICAL SYSTEM AS SHOWN ON THE DRAWINGS, CALLED FOR IN THE SPECIFICATIONS, AND AS REQUIRED BY JOB CONDITIONS. ALL WORK NOT SPECIFICALLY NOTED AS BEING BY THE LANDLORD OR ARCHITECTS SHALL BE PROVIDED BY THIS CONTRACTOR. CLOSELY COORDINATE THE ENTIRE INSTALLATION WITH THE LANDLORD AND ARCHITECTS, AS REQUIRED.
- 2. THE DRAWINGS AND SPECIFICATIONS ARE INTENDED TO SUPPLEMENT EACH OTHER AND ANY MATERIAL OR LABOR CALLED FOR IN ONE SHALL BE FURNISHED AND INSTALLED EVEN THOUGH NOT SPECIFICALLY MENTIONED IN BOTH. ANY MATERIAL OR LABOR WHICH IS NEITHER SHOWN ON THE DRAWINGS NOR CALLED FOR IN THE SPECIFICATIONS, BUT WHICH IS OBVIOUSLY NECESSARY TO COMPLETE THE WORK, AND WHICH IS USUALLY INCLUDED IN WORK OF SIMILAR CHARACTER, SHALL BE FURNISHED AND INSTALLED AS PART OF THE CONTRACT.
- WHERE THE DRAWINGS OR SPECIFICATIONS CALL FOR ITEMS WHICH EXCEED CODES OR THE LANDLORD'S TENANT CRITERIA, THE CONTRACTOR IS RESPONSIBLE FOR FURNISHING AND INSTALLING THE SYSTEM WITH THE MORE STRINGENT REQUIREMENTS AS DESIGNED AND DESCRIBED ON THESE DRAWINGS, UNLESS SPECIFICALLY NOTED
- 4. ALL WORK IN THIS SECTION SHALL BE INSTALLED SO AS TO BE READILY ACCESSIBLE FOR OPERATING, SERVICING, MAINTAINING, AND REPAIRING. THIS CONTRACTOR IS RESPONSIBLE FOR PROVIDING SUFFICIENT SERVICE ACCESS
- 5. ALL WORK SHALL BE PERFORMED IN A NEAT PROFESSIONAL MANNER USING GOOD CONSTRUCTION PRACTICES.
- 6. UNLESS SPECIFICALLY NOTED OTHERWISE, MATERIALS, PRODUCTS, AND EQUIPMENT, INCLUDING ALL COMPONENTS THEREOF, SHALL BE NEW, UNDERWRITERS LABORATORIES LISTED AND LABELED AND SIZED IN CONFORMITY WITH REQUIREMENTS OF STATE AND LOCAL CODES, WHICHEVER IS MORE STRINGENT.
- 7. THIS CONTRACTOR SHALL DO ALL CUTTING, CHASING AND CHANNELING REQUIRED FOR ANY WORK UNDER THIS DIVISION. CUTTING SHALL HAVE PRIOR APPROVAL BY THE ARCHITECTS AND THE LANDLORD. ALL PATCHING SHALL BE BY G.C. AND SHALL MATCH THE SURROUNDING SURFACES.
- 8. THE ELECTRICAL CONTRACTOR SHALL MAKE ALL FINAL ELECTRICAL CONNECTIONS AS REQUIRED FOR A COMPLETE AND OPERATING SYSTEM.

C. TEMPORARY LIGHT AND POWER

- 1. THIS CONTRACTOR SHALL FURNISH AND INSTALL ALL TEMPORARY WIRING AND RELATED GROUND FAULT INTERRUPTION PROTECTION FOR LIGHT AND POWER FOR ALL CONTRACTORS AND SHALL BE RESPONSIBLE FOR THE REMOVAL OF ALL TEMPORARY WIRING.
- 2. THE GENERAL CONTRACTOR SETS UP ALL ELECTRICAL UTILITIES IN THE NAME OF THE TENANT. TENANT PAYS FOR ALL UTILITIES THROUGHOUT CONSTRUCTION.

1. ALL WORK SHALL CONFORM TO THE LANDLORD'S CRITERIA, THE STATE'S, COUNTY'S, CITY'S AND LOCAL CODES AND ORDINANCES, SAFETY AND HEALTH CODES, NFPA CODES, ENERGY CODES AND ALL OTHER APPLICABLE CODES AND REQUIREMENTS. THIS CONTRACTOR SHALL INQUIRE INTO AND COMPLY WITH ALL APPLICABLE CODES. ORDINANCES, AND REGULATIONS. THIS CONTRACTOR SHALL INCLUDE ANY CHANGES REQUIRED BY CODES IN THE BID AND IF THESE CHANGES ARE NOT INCLUDED IN THE BID. THEY MUST BE QUALIFIED AS A SEPARATE LINE ITEM IN THE BID. AFTER CONTRACT IS AWARDED. CHANGE ORDERS FOR INCREASED COSTS DUE TO CODE ISSUES WILL NOT BE ACCEPTED BY OWNER, UNLESS ALLOWANCES HAVE PREVIOUSLY BEEN AGREED UPON.

E. <u>LICENSES</u>, PERMITS, INSPECTIONS & FEES

- 1. THIS CONTRACTOR SHALL OBTAIN AND PAY FOR ALL LICENSES, PERMITS, INSPECTIONS, AND FEES REQUIRED OR RELATED TO HIS WORK
- 2. FURNISH TO ARCHITECTS ALL CERTIFICATES OF INSPECTION AND FINAL INSPECTION APPROVAL AT COMPLETION OF

F. TRADE NAMES, MANUFACTURERS AND SHOP DRAWINGS

- 1. WHERE TRADE NAMES AND MANUFACTURERS ARE USED ON THE DRAWINGS OR IN THE SPECIFICATIONS, THE EXACT EQUIPMENT SHALL BE USED AS A MINIMUM FOR THE BASE BID. MANUFACTURERS CONSIDERED AS AN EQUAL OR BETTER IN ALL ASPECTS TO THAT SPECIFIED WILL BE SUBJECT TO APPROVAL IN WRITING BY ARCHITECTS/ENGINEERS THROUGH SHOP DRAWING SUBMITTAL PROCESS FOR ACCEPTANCE PRIOR TO INSTALLATION. THE USE OF ANY UNATHORIZED EQUIPMENT SHALL BE REPLACED AT THE CONTRACTOR'S EXPENSE.
- 2. GENERAL CONTRACTOR SHALL SUBMIT ONLY SUBSTITUTION REQUESTS TO ARCHITECTS/ENGINEERS FOR APPROVAL. SUBMISSIONS SHALL BE MADE EARLY ENOUGH IN PROJECT TO ALLOW FOUR (4) WORKING DAYS FOR ARCHITECTS/ENGINEERS REVIEW WITHOUT CAUSING DELAYS OR CONFLICTS TO THE JOB'S PROGRESS. SUBMITTALS SHALL BEAR THE STAMP AND/OR THE SIGNATURE OF THE GENERAL CONTRACTOR AND THE SUB-CONTRACTOR SHOWING THAT HE HAS REVIEWED AND CONFIRMED THAT THE SUBMITTALS ARE IN CONFORMANCE WITH THE CONTRACT DRAWINGS AND SPECIFICATIONS OR INDICATE WHERE EXCEPTIONS HAVE BEEN TAKEN.

G. <u>GUARANTEE</u>

1. THE EQUIPMENT MANUFACTURER SHALL PROVIDE A 12 MONTH GUARANTEE TO TENANT FROM THE DATE OF ACCEPTANCE. THIS CONTRACTOR SHALL WARRANTY THE INSTALLATION OF THIS EQUIPMENT AND WILL BE RESPONSIBLE FOR ANY DAMAGE AND/OR MALFUNCTION CAUSED BY THE INSTALLATION. THIS CONTRACTOR SHALL NOT BEAR ADDITIONAL WARRANTIES BEYOND A COMPLETE WORKING SYSTEM.

H. RECORD DRAWINGS

- 1. THIS CONTRACTOR SHALL MAINTAIN ONE SET OF DRAWINGS ON THE JOB SITE UPDATED WEEKLY TO RECORD ALL DEVIATIONS FROM CONTRACT DRAWINGS, SUCH AS:
- a. LOCATION OF CONCEALED CONDUIT AND EQUIPMENT.
- b. REVISIONS, ADDENDUMS, AND CHANGE ORDERS.
- c. SIGNIFICANT DEVIATIONS MADE NECESSARY BY FIELD CONDITIONS, APPROVED EQUIPMENT SUBSTITUTIONS, AND CONTRACTOR'S COORDINATION WITH OTHER TRADES.
- 2. AT COMPLETION OF THE PROJECT AND BEFORE FINAL APPROVAL, THIS CONTRACTOR SHALL MAKE ANY FINAL CORRECTIONS TO DRAWINGS AND CERTIFY THE ACCURACY OF EACH PRINT BY SIGNATURE THEREON. FAILURE TO KEEP THESE RECORDS WILL ALLOW TENANT/ARCHITECTS TO DIRECT THE GENERAL CONTRACTOR TO PROVIDE THESE RECORDS AT HIS EXPENSE PRIOR TO FINAL PAYMENT.

DISCREPANCIES IN DOCUMENTS

1. DRAWINGS (PLANS, SPECIFICATIONS, AND DETAILS) ARE DIAGRAMMATIC AND INDICATE THE GENERAL LOCATION AND INTENT OF THE ELECTRICAL SYSTEMS. WHERE DRAWINGS, EXISTING SITE CONDITIONS, SPECIFICATIONS OR OTHER TRADES CONFLICT OR ARE LINCLEAR ADVISE THE GENERAL CONTRACTOR IN WRITING PRIOR TO SUBMITTAL OF BID. THE GENERAL CONTRACTOR IS RESPONSIBLE TO ADVISE PROJECT MANAGER, IN WRITING, OF VARIATIONS TO CONTRACT DOCUMENTS PRIOR TO SUBMISSION OF BID. OTHERWISE, TENANT/ARCHITECT'S INTERPRETATION OF CONTRACT DOCUMENTS OR CONDITIONS SHALL BE FINAL WITH NO ADDITIONAL COMPENSATION PERMITTED.

PHASING REQUIREMENTS

1. THIS CONTRACTOR IS TO INCLUDE IN HIS BID ALL NECESSARY SERVICE REQUIRED TO KEEP THE OPERATING PHASE OF THE STORE'S ELECTRICAL SERVICE IN OPERATION. CONTRACTOR MUST SCHEDULE IN WRITING WITH TENANT/ARCHITECTS AND THE LANDLORD ONE WEEK PRIOR TO ANY SHUT DOWN OF THE ELECTRICAL SYSTEM.

K. <u>DEMOLITION</u>

1. THIS CONTRACTOR SHALL BE RESPONSIBLE FOR THE COORDINATION OF THE DEMOLITION OF EXISTING WORK AND THE DEMOLITION PROVIDED BY THE GENERAL CONTRACTOR. COORDINATE WITH THE GENERAL CONTRACTOR ANY EXISTING EQUIPMENT REQUIRED TO BE LEFT INTACT.

ELECTRICAL SPECIFICATIONS (AS APPLICABLE)

2. THIS CONTRACTOR SHALL INCLUDE, AND WILL BE HELD RESPONSIBLE FOR, THE REMOVAL OF ALL EXISTING ELECTRICAL EQUIPMENT, CONDUITS, ETC. NOT TO BE REUSED ON THIS PROJECT, UNLESS SPECIFICALLY NOTED OTHERWISE. CONTRACTOR MUST VERIFY WITH THE LANDLORD ALL PRESUMED ABANDONED EQUIPMENT PRIOR TO REMOVAL. ALL EXTRANEOUS ITEMS IN THE SPACE OR ON THE ROOF NOT APPLICABLE TO THE NEW WORK MUST BE REMOVED AND ROOF/WALL/FLOOR PATCHED/REPAIRED TO MATCH EXISTING STRUCTURE. EXISTING ABANDONED CONDUIT OR EQUIPMENT IN THE FLOOR, EMBEDDED IN CONCRETE OR OTHERWISE INACCESSIBLE ARE TO BE CUT OFF AND SEALED BELOW OR WITHIN FLOOR OR WALL LEVEL WHEN THEY ARE NOT TO BE REUSED IN THIS PROJECT. IF REQUIRED BY LANDLORD OR CODES, ABANDONED CONDUIT MUST BE REMOVED TO POINT OF ORIGIN. CONFIRM THE EXTENT OF DEMOLITION PRIOR TO BID AND INCLUDE IN BID PROPOSAL.

- 1. THIS CONTRACTOR SHALL PROVIDE SLEEVES TO PROTECT EQUIPMENT OR FACILITIES IN THE INSTALLATION. EACH SLEEVE SHALL EXTEND THROUGH IT'S RESPECTIVE FLOOR, WALL OR PARTITION AND SHALL BE CUT FLUSH WITH EACH SURFACE EXCEPT SLEEVES THAT PENETRATE THE FLOOR, WHICH SHALL EXTEND 2" ABOVE THE FLOOR. CONTRACTOR MUST COORDINATE THROUGH THE LANDLORD ANY CORE DRILLING OR CUTTING OF OPENINGS IN MASONRY FLOORS OR WALLS.
- 2. ALL SLEEVES AND OPENINGS THROUGH FIRE RATED WALLS AND/OR FLOORS SHALL BE FIRE SEALED WITH CALCIUM SILICATE, SILICONE "RTV" FOAM, "3M" FIRE RATED SEALANTS OR EQUAL, SO AS TO RETAIN THEIR FIRE RATING.
- 3. SLEEVES IN BEARING AND MASONRY WALLS, FLOORS, AND PARTITIONS SHALL BE STANDARD WEIGHT STEEL PIPE FINISHED WITH SMOOTH EDGES, FOR OTHER THAN MASONRY PARTITIONS, THROUGH SUSPENDED CEILINGS, OR

FOR CONCEALED VERTICAL PIPING, SLEEVES SHALL BE NO. 22 U.S.G. GALVANIZED STEEL MINIMUM.

M. <u>HANGERS</u>

- HANGERS SHALL INCLUDE ALL MISCELLANEOUS STEEL SUCH AS ANGLE IRON, BANDS, C-CLAMPS WITH RETAINING CLIPS, CHANNELS, HANGER RODS, ETC., NECESSARY FOR THE INSTALLATION OF WORK.
- 2. HANGERS SHALL BE FASTENED TO BUILDING STEEL, CONCRETE, OR MASONRY, BUT NOT TO PIPING. HANGING FROM METAL DECK IS NOT PERMITTED. HANGERS MUST BE ATTACHED TO UPPER CHORD OF BAR JOIST. WHERE INTERFERENCES OCCUR, AND IN ORDER TO SUPPORT DUCTWORK OR PIPING, THE CONTRACTOR MUST INSTALL TRAPEZE TYPE HANGERS OR SUPPORTS WHICH SHALL BE LOCATED WHERE THEY DO NOT INTERFERE WITH ACCESS TO FIRE DAMPERS, VALVES, AND OTHER EQUIPMENT. HANGER TYPES AND INSTALLATION METHODS ARE ALSO SUBJECT TO LANDLORD CRITERIA.
- 3. HANGERS AND PIPING OF DISSIMILAR METALS SHALL BE DIELECTRICALLY SEPARATED.

N. FINAL ELECTRICAL INSPECTIONS

ASIDE FROM NORMAL INTERIM INSPECTIONS OF WORK IN PLACE, TENANT/ARCHITECTS MAY HAVE AN INDEPENDENT ELECTRICAL CONTRACTOR INSPECT THE FINISHED ELECTRICAL INSTALLATION UPON COMPLETION FOR COMPLIANCE WITH THE PLANS, SPECIFICATIONS AND CODES. THE INSTALLING CONTRACTOR WILL BE RESPONSIBLE TO BRING ALL ITEMS REPORTED BY THE INDEPENDENT ELECTRICAL CONTRACTOR UP TO PLANS AND SPECIFICATION REQUIREMENTS.

END OF SECTION 16000

<u>SECTION 16050</u>

BASIC ELECTRICAL MATERIAL AND METHODS

A. <u>CONTRACTOR NOTES</u>

- 1. IT IS CONTRACTOR/ELECTRICIANS' RESPONSIBILITY TO FIELD VERIFY ACTUAL SITE CONDITION AND SHALL NOTIFY EOR(S) ANY DISCREPANCIES WITH THE PLAN THAT IMPACTS ON THE BID PRIOR TO BIDDING.
- 2. THIS CONTRACTOR SHALL FURNISH ALL LABOR, MATERIALS, EQUIPMENT, SERVICES, TOOLS, TRANSPORTATION, AND FACILITIES NECESSARY FOR, REASONABLY IMPLIED AND INCIDENTAL TO, THE FURNISHING, INSTALLATION, COMPLETION AND TESTING OF ALL THE WORK FOR THE ELECTRICAL SYSTEMS AS SHOWN ON THE DRAWINGS, CALLED FOR IN THE SPECIFICATIONS, AND AS REQUIRED BY JOB CONDITIONS, TO INCLUDE, BUT NOT BE LIMITED TO THE FOLLOWING
- a. A COMPLETE ELECTRICAL DISTRIBUTION SYSTEM INCLUDING THE INSTALLATION OF SAFETY AND DISCONNECT SWITCHES, MOTOR STARTERS AND LIGHTING. IT IS THE ELECTRICAL CONTRACTOR'S RESPONSIBILITY TO INCLUDE IN HIS BID FOR PROVIDING SERVICE FOUIPMENT NECESSARY FOR TIE-IN TO LANDLORD'S DISTRIBUTION EQUIPMENT OR TO OBTAIN SERVICE FROM LOCAL UTILITY COMPANY. REFER TO ELECTRICAL RESPONSIBILITY SCHEDULE AND ELECTRICAL POWER RISER DIAGRAM FOR ADDITIONAL INFORMATION.
- b. CONTRACTOR MUST ALSO INCLUDE IN BID ALL NECESSARY MATERIALS REQUIRED TO COMPLETE THE SYSTEM INCLUDING, BUT NOT LIMITED TO, FEEDERS, BRANCH CIRCUITS, JUNCTION BOXES, OUTLET BOXES, WIRING DEVICES, COVER PLATES, CONDUITS, ETC.
- c. METERING AND CURRENT TRANSFORMERS AS REQUIRED BY DRAWINGS, UTILITY COMPANY, AND/OR LANDLORD.
- d. THE WIRING OF MECHANICAL EQUIPMENT AS OUTLINED ON THE BID SET DRAWINGS AND IN THE SPECIFICATIONS. WORK SHALL INCLUDE WIRING OF ALL STARTERS, DISCONNECTS, AND POWER WIRING OF MECHANICAL EQUIPMENT EXCEPT AS SPECIFICALLY NOTED OTHERWISE. ALL LOW VOLTAGE (24 VOLT) EMS TEMPERATURE CONTROL WIRING SHALL BE THE RESPONSIBILITY OF THE ELECTRICAL CONTRACTOR UNLESS NOTED SPECIFICALLY ON DRAWING.
- e. INSTALLATION OF LIGHT FIXTURES AND LAMPS AS SHOWN ON THE DRAWINGS INCLUDING ALL DEVICES, EQUIPMENT, ETC. REQUIRED FOR MOUNTING.
- f. A COMPLETE CONDUIT SYSTEM FOR TELEPHONE/DATA INCLUDING BRANCH CONDUITS, OUTLET BOXES, PULL WIRES, GROUND CONDUCTORS, COVER PLATES, ETC. OR AS SPECIFICALLY NOTED OTHERWISE ON THE
- g. A COMPLETE EMERGENCY AND EXIT LIGHTING SYSTEM AS SHOWN ON THE DRAWINGS.
- h. TEMPORARY SERVICE AS INDICATED IN THE SPECIFICATIONS, INCLUDING ITS REMOVAL.
- i. FINAL CONNECTIONS TO ALL SIGNS, CORNICE LIGHTING, CASE LIGHTING, ETC. AS SHOWN ON DRAWINGS.
- j. IF INDICATED ON DRAWINGS, INSTALLATION AND WIRING OF SPEAKERS, AMPLIFIERS, CONDUIT AND FINAL CONNECTIONS FOR SOUND SYSTEM AS SHOWN.
- NECESSARY TO MEET LANDLORD, STATE, LOCAL, INSURANCE AND FIRE DEPARTMENT REQUIREMENTS.
- I. INSTALLATION OF CONDUITS STUBBED TO ABOVE CEILING FOR HVAC. ALSO, ANY ADDITIONAL CONDUIT FOR HVAC CONTROL EQUIPMENT WHERE PLENUM RATED CABLES ARE NOT PERMITTED.

k. SMOKE/FIRE ALARM WIRING, DEVICES AND CONDUIT, AS SHOWN OR DESCRIBED ON DRAWINGS OR AS

- m. BALANCING LOADS.
- n. AS-BUILTS, PANEL DESCRIPTION AND CIRCUIT BREAKER SPECIFIC LABELING.
- 3. THE FOLLOWING ITEMS OF ELECTRICAL CONSTRUCTION ARE NOT INCLUDED IN THIS CONTRACT:
- a. TELEPHONE INSTRUMENTS AND WIRING UNLESS NOTED OTHERWISE.
- b. DATA CABLE WIRING UNLESS NOTED OTHERWISE.
- BEFORE STARTING WORK, THIS CONTRACTOR SHALL EXAMINE THE ARCHITECTURAL, STRUCTURAL, FIRE PROTECTION, MECHANICAL AND PLUMBING PLANS, SHOP DRAWINGS AND SPECIFICATIONS TO SEQUENCE, COORDINATE. AND INTEGRATE THE VARIOUS ELEMENTS OF THE ELECTRICAL SYSTEM. MATERIALS AND EQUIPMENT WITH OTHER CONTRACTORS TO AVOID INTERFERENCES AND CONFRONTATIONS.

B. <u>CONDUIT</u>

- THIS CONTRACTOR SHALL FURNISH AND INSTALL ALL CONDUITS SERVING ALL EQUIPMENT, INCLUDING BUT NOT LIMITED TO. LIGHTING, RECEPTACLES, HEATING, AIR CONDITIONING, PLUMBING EQUIPMENT, TELEPHONE, DATA, SPEAKERS, SECURITY, PAGER, TRAFFIC COUNTING SYSTEM AND ELECTRICAL EQUIPMENT.
- 2. ALL CONDUITS SHALL BE GALVANIZED IMC OR EMT UNLESS OTHERWISE SPECIFIED IN SPECIFICATIONS OR ON DRAWINGS. ALL CONDUIT IS TO BE UL LABELED. EMT CONNECTORS SHALL BE STEEL COMPRESSION OR SET SCREW TYPE. CONDUIT UNDER SLAB ON GRADE SHALL BE RIGID STEEL, OR SCHEDULE 40 PVC WITH RIGID STEEL ELLS WHERE PERMITTED BY LANDLORD OR CODE. EMT FOR WET LOCATIONS TO BE PERMITTED ONLY WHEN ALL SUPPORTS, BOLTS, STRAPS, SCREWS AND SO FORTH ARE CORRISION-RESISTANT MATERAILS PER 358.10.

3. MINIMUM SIZE OF CONDUIT SHALL BE:

- a. MAIN FEEDER CONDUIT 2" OR LARGER FOR ALL APPLICATIONS.
- b. 1/2" FOR INDIVIDUAL LIGHTING FIXTURE CONNECTIONS OR TO INDIVIDUAL LIGHT SWITCHES (IF ACCEPTABLE BY THE LANDLORD AND LOCAL CODE OFFICIALS) AND 3/4" FOR ALL OTHER LOCATIONS.

- c. IF HVAC CONTROL WIRING IS REQUIRED TO BE RUN IN CONDUIT, IT SHALL BE A MINIMUM OF 3/4", UNLESS NOTED OTHERWISE ON DRAWINGS.
- d. ALL IN/UNDER FLOOR CONDUIT SHALL BE OF MINIMUM 3/4" SIZE.
- 4. SUPPORT ALL CONDUIT, INCLUDING SEISMIC AND SWAY BRACING, IN ACCORDANCE WITH THE NEC AND LOCAL
- GENERALLY, ALL CONDUIT SHALL BE CONCEALED EXCEPT FOR UNFINISHED AREAS, SUCH AS EQUIPMENT ROOMS. EXPOSED CONDUIT SHALL BE ALLOWED ONLY AS NOTED ON PLAN AND AS APPROVED BY PROJECT MANAGER. PAINTING OF CONDUITS, NOTED ON DRAWINGS OR SPECIFICATIONS WILL BE BY GENERAL CONTRACTOR.
- 6. FLEXIBLE METAL CONDUIT OR MC TYPE CABLE:
 - a. FLEXIBLE CONDUIT OR MC TYPE CABLE SHALL BE USED FOR THE FOLLOWING APPLICATIONS ONLY:
 - FINAL CONNECTIONS TO MOTORS.
 - 2. FINAL CONNECTIONS INTO AND OUT OF THE TRANSFORMER.
 - 3. FINAL CONNECTIONS TO VIBRATING EQUIPMENT.
 - 4. INTER-CONNECTIONS BETWEEN ALL LIGHT FIXTURES AND HOMERUNS TO PANELS WHERE CODE ALLOWS.

6. IN WALLS (FOR LIGHT SWITCHES AND 120 VOLT POWER RECEPTACLES AND HVAC CONTROL EQUIPMENT).

FINAL CONNECTIONS WHERE RIGID CONDUIT IN NOT PRACTICAL

d. CONNECTION TO ANY OUTDOOR EQUIPMENT MUST BE WEATHERPROOF.

- b. FLEXIBLE METAL CONDUIT OR MC TYPE CABLE MUST BE THE SAME SIZE AS THE IMC OR EMT CONDUIT TO WHICH IT IS CONNECTED. BOTH THE FLEXIBLE METAL CONDUIT AND IT'S FITTINGS ARE TO BE LISTED FOR
- GROUNDING. A GREEN GROUNDING CONDUCTOR SHALL BE INSTALLED. ALL CONNECTORS ARE TO BE OF A
- c. THE USE OF ROMEX, BX, ETC. IS PERMITTED ONLY IN RESIDENTIAL CONSTRUCTION NOT HIGHER THAN THREE
- 7. PROVIDE PULL-WIRE IN ALL EMPTY CONDUITS EXCEPT AS NOTED OTHERWISE ON DRAWINGS.
- 8. HOME RUNS AND MAIN CONDUIT RUNS ARE TO BE HELD TIGHT TO STRUCTURE ABOVE OR AS REQUIRED TO ALLOW PROPER SERVICE ACCESS AND OTHER TRADES WORK. CONDUIT MUST BE TRAPEZED TO ALLOW 3 FEET MINIMUM
- 9. ALL CONDUITS MUST BE SIZED PER NEC AND LOCAL CODES.
- 10. ALL SENSORMATIC WIRING MUST BE PLACED IN CONDUIT (PVC PIPE NOT PERMITTED).

- 1. ALL OUTLET BOXES SHALL BE GALVANIZED PRESSED STEEL OF THE STANDARD KNOCKOUT TYPE. NO ROUND OUTLET BOXES SHALL BE PERMITTED UNLESS INDICATED AND FOR LIGHTING THAT REQUIRE SUCH CONFIGURATION. CONCEALED BOXES SHALL NOT BE LESS THAN 4" SQUARE AND 1 1/2" DEEP, WITH PLASTER RINGS.
- ALL KNOCKOUT BOXES, UPON WHICH LIGHTING FIXTURES ARE TO BE INSTALLED, SHALL BE EQUIPPED WITH 3/8" FIXTURE STUDS.
- 3. EXTERIOR BOXES SHALL BE CAST RUST-RESISTING METAL WITH GASKETED COVERS.
- INSTALL BOXES RIGIDLY FROM BUILDING STRUCTURE AND SUPPORT INDEPENDENTLY OF THE CONDUIT SYSTEM. ALSO PROVIDE SUITABLE BOX EXTENSIONS TO EXTEND BOXES TO FINISHED FACES OF FLOORS, CEILINGS, WALLS ETC. ALL OUTLET BOXES TO BE PROVIDED WITH CADDY "QUICK-MOUNT BOX SUPPORT" TO MINIMIZE THE DEFLECTION THAT OCCURS WHEN PLUGGING/UNPLUGGING INTO THESE DEVICES.
- UNLESS OTHERWISE NOTED ON DRAWINGS OR OTHERWISE REQUIRED BY THE NATIONAL ELECTRICAL CODE HANDICAP CODES OR LOCAL CODES, OUTLET HEIGHTS SHALL BE AS FOLLOWS:
- a. SWITCH HEIGHT 48" FROM FINISHED FLOOR TO TOP OF OUTLET.
- b. CONVENIENCE OUTLETS:

CLEARANCE ABOVE CEILING.

- MOUNTED ON WALL NO MORE THAN 48-INCHES, MEASURED FROM TO TOP OF THE RECEPTACLE OUTLET BOX OR RECEPTACLE HOUSING AND; NO LESS THAN 15-INCHES, MEASURED FROM THE BOTTOM OF THE RECEPTACLE OUTLET BOX OR RECEPTACLE HOUSING. TO THE LEVEL OF THE FINISHED FLOOR OR WORKING PLATFORM UNLESS OTHERWISE INDICATED OR HORIZONTALLY MOUNTED IN BASEBOARD BENEATH CABINETS, AS SHOWN ON DRAWINGS, OR AS REQUIRED BY LOCAL CODES, SEE DRAWINGS.
- c. TELEPHONE OUTLETS SHALL BE LOCATED AS NOTED ON DRAWINGS.

JUNCTION AND PULL BOXES

- 1. THE PLANS INDICATE ONLY SCHEMATIC ROUTINGS FOR CONDUIT RUNS. THIS CONTRACTOR SHALL FURNISH AND INSTALL ADDITIONAL BOXES WHERE REQUIRED BY FIELD CONDITIONS OR BY CODE.
- 2. BOXES AND COVERS SHALL BE GALVANIZED STEEL OF CODE GAUGE SIZE.
- INSTALL BOXES RIGIDLY SUPPORTED FROM THE BUILDING STRUCTURE AND SUPPORTED INDEPENDENT OF THE CONDUIT SYSTEM.
- ARRANGE CIRCUITS TO AVOID THE USE OF JUNCTION BOXES IN INACCESSIBLE LOCATIONS. THE USE OF JUNCTION BOXES ABOVE DRYWALL CEILINGS SHOULD BE LIMITED TO LOCATIONS NEAR ACCESS FRAMES USED FOR DIFFUSERS AND RETURN AIR GRILLES OR ACCESS PANELS AS LOCATED ON PLANS.
- 5. JUNCTION AND PULL BOXES MUST BE LABELED WITH CIRCUIT NUMBER IDENTIFICATION AND SYSTEM TYPE ON COVER.

WIRING

- CONDUCTORS FOR FEEDERS AND BRANCH CIRCUITS SHALL BE COPPER AND THE AWG SIZE AND TYPE AS SHOWN ON DRAWINGS. MINIMUM WIRE SIZE #12. THE CONDUCTORS SHALL BE 600 VOLT INSULATION, TYPE THW, THWN OR
- MINIMUM WIRE SIZE 20 AMP BRANCH CIRCUIT SHALL BE AWG LISTED SIZE PER DISTANCE SHOWN BELOW.
- DISTANCE SHALL BE MEASURED FROM THE PANELBOARD CIRCUIT BREAKER TO THE FURTHEST OUTLET. a. #12 LESS THAN 100 FEET
- b. #10 BETWEEN 100-150 FEET
- c. #8 BETWEEN 150 250 FEET
- d. #6 OVER 250 FEET
- ON ALL 20 AMP BRANCH CIRCUITS, CONDUCTORS LARGER THAN #10 AWG SHALL BE REDUCED TO #10 AWG WITHIN 10 FEET OF PANEL BOARD AND DEVICE IN JUNCTION BOXES ON RATED TERMINAL STRIPS.
- 4. CONDUCTORS MAY BE STRANDED FOR SIZES #10 AWG AND LARGER. CONDUCTORS SIZE #12 SHALL BE SOLID (NOT

ALUMINUM CONDUCTORS ARE NOT PERMITTED, EXCEPT AT SERVICE ENTRANCE, WHERE REQUIRED BY LANDLORD.

CONDUCTOR CONNECTION MUST BE PER MANUFACTURER'S REQUIREMENTS. CONTRACTOR MUST OBTAIN WRITTEN

- PERMISSION FROM GENERAL CONTRACTOR AND PROJECT MANAGER WHEN USED. ALL WIRING (120V AND ABOVE) SHALL BE IN CONDUIT, UNLESS SPECIFICALLY NOTED OTHERWISE. ALL LOW VOLTAGE WIRING CONDUIT REQUIREMENTS TO BE COORDINATED WITH OWNER.
- 7. THE USE OF SHARED NEUTRALS IS REQUIRED FOR LIGHTING CIRCUITS AND SHALL BE INSTALLED IN ACCORDANCE WITH THE NATIONAL ELECTRICAL CODE AND LOCAL CODES. ALL OTHER EQUIPMENT REQUIRING A NEUTRAL CONDUCTOR SHALL HAVE A DEDICATED FULL SIZE NEUTRAL.
- 8. THE USE OF ROMEX, BX, ETC. IS PERMITTED ONLY IN RESIDENTIAL CONSTRUCTION NOT HIGHER THAN THREE
- WIRE CONNECTORS SHALL BE EQUAL TO "SCOTCH LOCK" FOR #8 AWG WIRE AND SMALLER AND EQUAL TO T & B "LOCKTIGHT" FOR #6 AWG AND LARGER.

10. ALL WIRING TO BE COLOR-CODED AS FOLLOWS:

GROUND - GREEN

120/208 VOLT SYSTEM 277/480 VOLT SYSTEM NEUTRAL - GRAY NEUTRAL - WHITE PHASE A OR L1 - BLACK PHASE A OR L1 - BROWN PHASE B 0R L2 - RED PHASE B 0R L2 - ORANGE PHASE C OR L3 - BLUE

PHASE C OR L3 - YELLOW **GROUND - GREEN WITH YELLOW TRACER**

DUPLEX RECEPTACLE AT +18" FOR WALL MOUNTED U.O.N. DOUBLE DUPLEX RECEPTACLE AT + 18" FOR WALL MOUNTED U.O.N. GROUND FAULT INTERRUPTING PROTECTED CIRCUIT DUPLEX RECEPTACLE PROVIDE GFCI BREAKER INSTEAD OF GFCI OUTLET AS NECESSARY DUPLEX RECEPTACLE WITH USB 2.0 PORT \otimes \otimes SPECIAL NEMA RECEPTACLE. SEE EQUIPMENT PLAN/INSTALLATION MANUAL FOR SPECS AND DETAILS. **О Ю** JUNCTION BOX COMBINATION TELEPHONE, DATA AND CABLE OUTLET AT +18" U.O.N. PROVIDE 1/2"C.O. STUBBED TO ACCESSIBLE CEILING SPACE TELEPHONE OUTLET; CAT5E CABLE. RJ11 TERMINATION MOUNTED AT +18" PROVIDE 1/2"C.O. STUBBED TO ACCESSIBLE CEILING SPACE DATA OUTLET: CAT5E CABLE. RJ45 TERMINATION MOUNTED AT +18" U.O.N. PROVIDE 1/2"C.O. STUBBED TO ACCESSIBLE CEILING SPACE CABLE OUTLET; RG-6 COAXIAL CABLE. MOUNTED AT +18" U.O.N. PROVIDE 1/2"C.O. STUBBED TO ACCESSIBLE CEILING SPACE LIGHTING FIXTURE WITH 90 MIN. EMER. BATTERY PACK OR ON INVERTER SEE LIGHT FIXTURE SCHEDULE FOR DETAILS AND SPECS CONDUIT STUB OUT, 3/4" MINIMUM - SEE PLANS FOR NOTES CONDUIT CONCEALED ABOVE CEILING OR IN WALLS HOMERUN TO PANEL "A", CIRCUITS #1 A-1 GROUND CONNECTOR **CEILING POWER DROP** ELECTRICAL PANEL. REFER TO PANEL SCHEDULE FOR DETAILS. MAIN SWITCHBOARD OR POWER DISTRIBUTION BOARD. VERIFY DIMENSION WITH VENDER/MANUFACTURER. DENOTES EQUIPMENT #1, SEE EQUIPMENT SCHEDULE FOR THE DETAILS AND EXACT SPECIFICATIONS. INDICATES PLAN NOTE NUMBER "1", SEE PLAN DENOTES MECHANICAL EQUIPMENT #1 SEE MECHANICAL DRAWINGS FOR THE DETAILS AND SPECIFICATIONS. SINGLE POLE SWITCH AT 48" U.O.N. THREE-WAY SWITCH AT +48" U.O.N. MANUAL MOTOR STARTER DIMMER SWITCH/DIMMING WALL CONTROL STATION AT +48" U.O.N. THREE-WAY DIMMER SWITCH AT +48" U.O.N. OCCUPANCY AUTOMATIC WALL SWITCH SENSOR WITH SINGLE LEVEL SWITCHING AT +48" U.O.N./MANUFACTURER TO BE DETERMINED VACANCY AUTOMATIC WALL SWITCH SENSOR WITH SINGLE LEVEL SWITCHING AT +48" U.O.N./MANUFACTURER TO BE DETERMINED OCCUPANCY SENSOR SINGLE POLE SWITCH WITH DIMMER CONTROL FEATURE AT +48" U.O.N./MANUFACTURER TO BE DETERMINED CEILING MOUNTED OCCUPANCY SENSOR MANUFACTURER TO BE DETERMINED CEILING MOUNTED VACANCY SENSOR MANUFACTURER TO BE DETERMINED CEILING MOUNTED DAYLIGHT SENSOR MANUFACTURER TO BE DETERMINED HARD WIRED, WITH BATTERY BACKUP, SMOKE DETECTOR/CARBON MONOXIDE DETECTOR/MULTI-PURPOSE (s) (c) (s/c CARBON MONIXIDE & SMOKE DETECTOR NON-FUSED/FUSED SWITCH, SIZE AS SHOWN IN THE PLAN MOTOR OUTLET - IDENTIFICATION EXECUSTANG CONTROCTOR AND SECTION OF SECTION TIME CLOCK WITH MANUAL BY-PASS SWITCH (N) / (E) / (R)ABBREVIATION FOR NEW / EXISTING / RELOCATED SYMBOL NOTES: SYMBOL LIST SHOW IN FOR GENERAL REFERENCE ONLY. A PRESENCE OF A SYMBOL DOES NOT IMPLY ITS USE ON THIS PROJECT. REFER TO DRAWING FOR SPECIFIC SYMBOLS USED. SHEET INDEX

ELECTRICAL SYMBOLS LIST

DESCRIPTION

WALL FLR

E000 ELECTRICAL SPECIFICATION E001 PHOTOMETRIC PLAN SPECIFICATIONS E002 E003 PHOTOMETRIC RENDERING

DRAWN: CHECKED J.L. DATE: SCALE: N.T.S. 09/27/2024

• EXISTING COMMERCIAL TENANT IMPROVEMENT

SCOPE OF WORK

PHOTOMETRIC PLAN FOR OUTDOOR AREAS.

ELECTRICAL SPECIFICATION

PLOT DATE: 4/3/2025 5:03:42 PM

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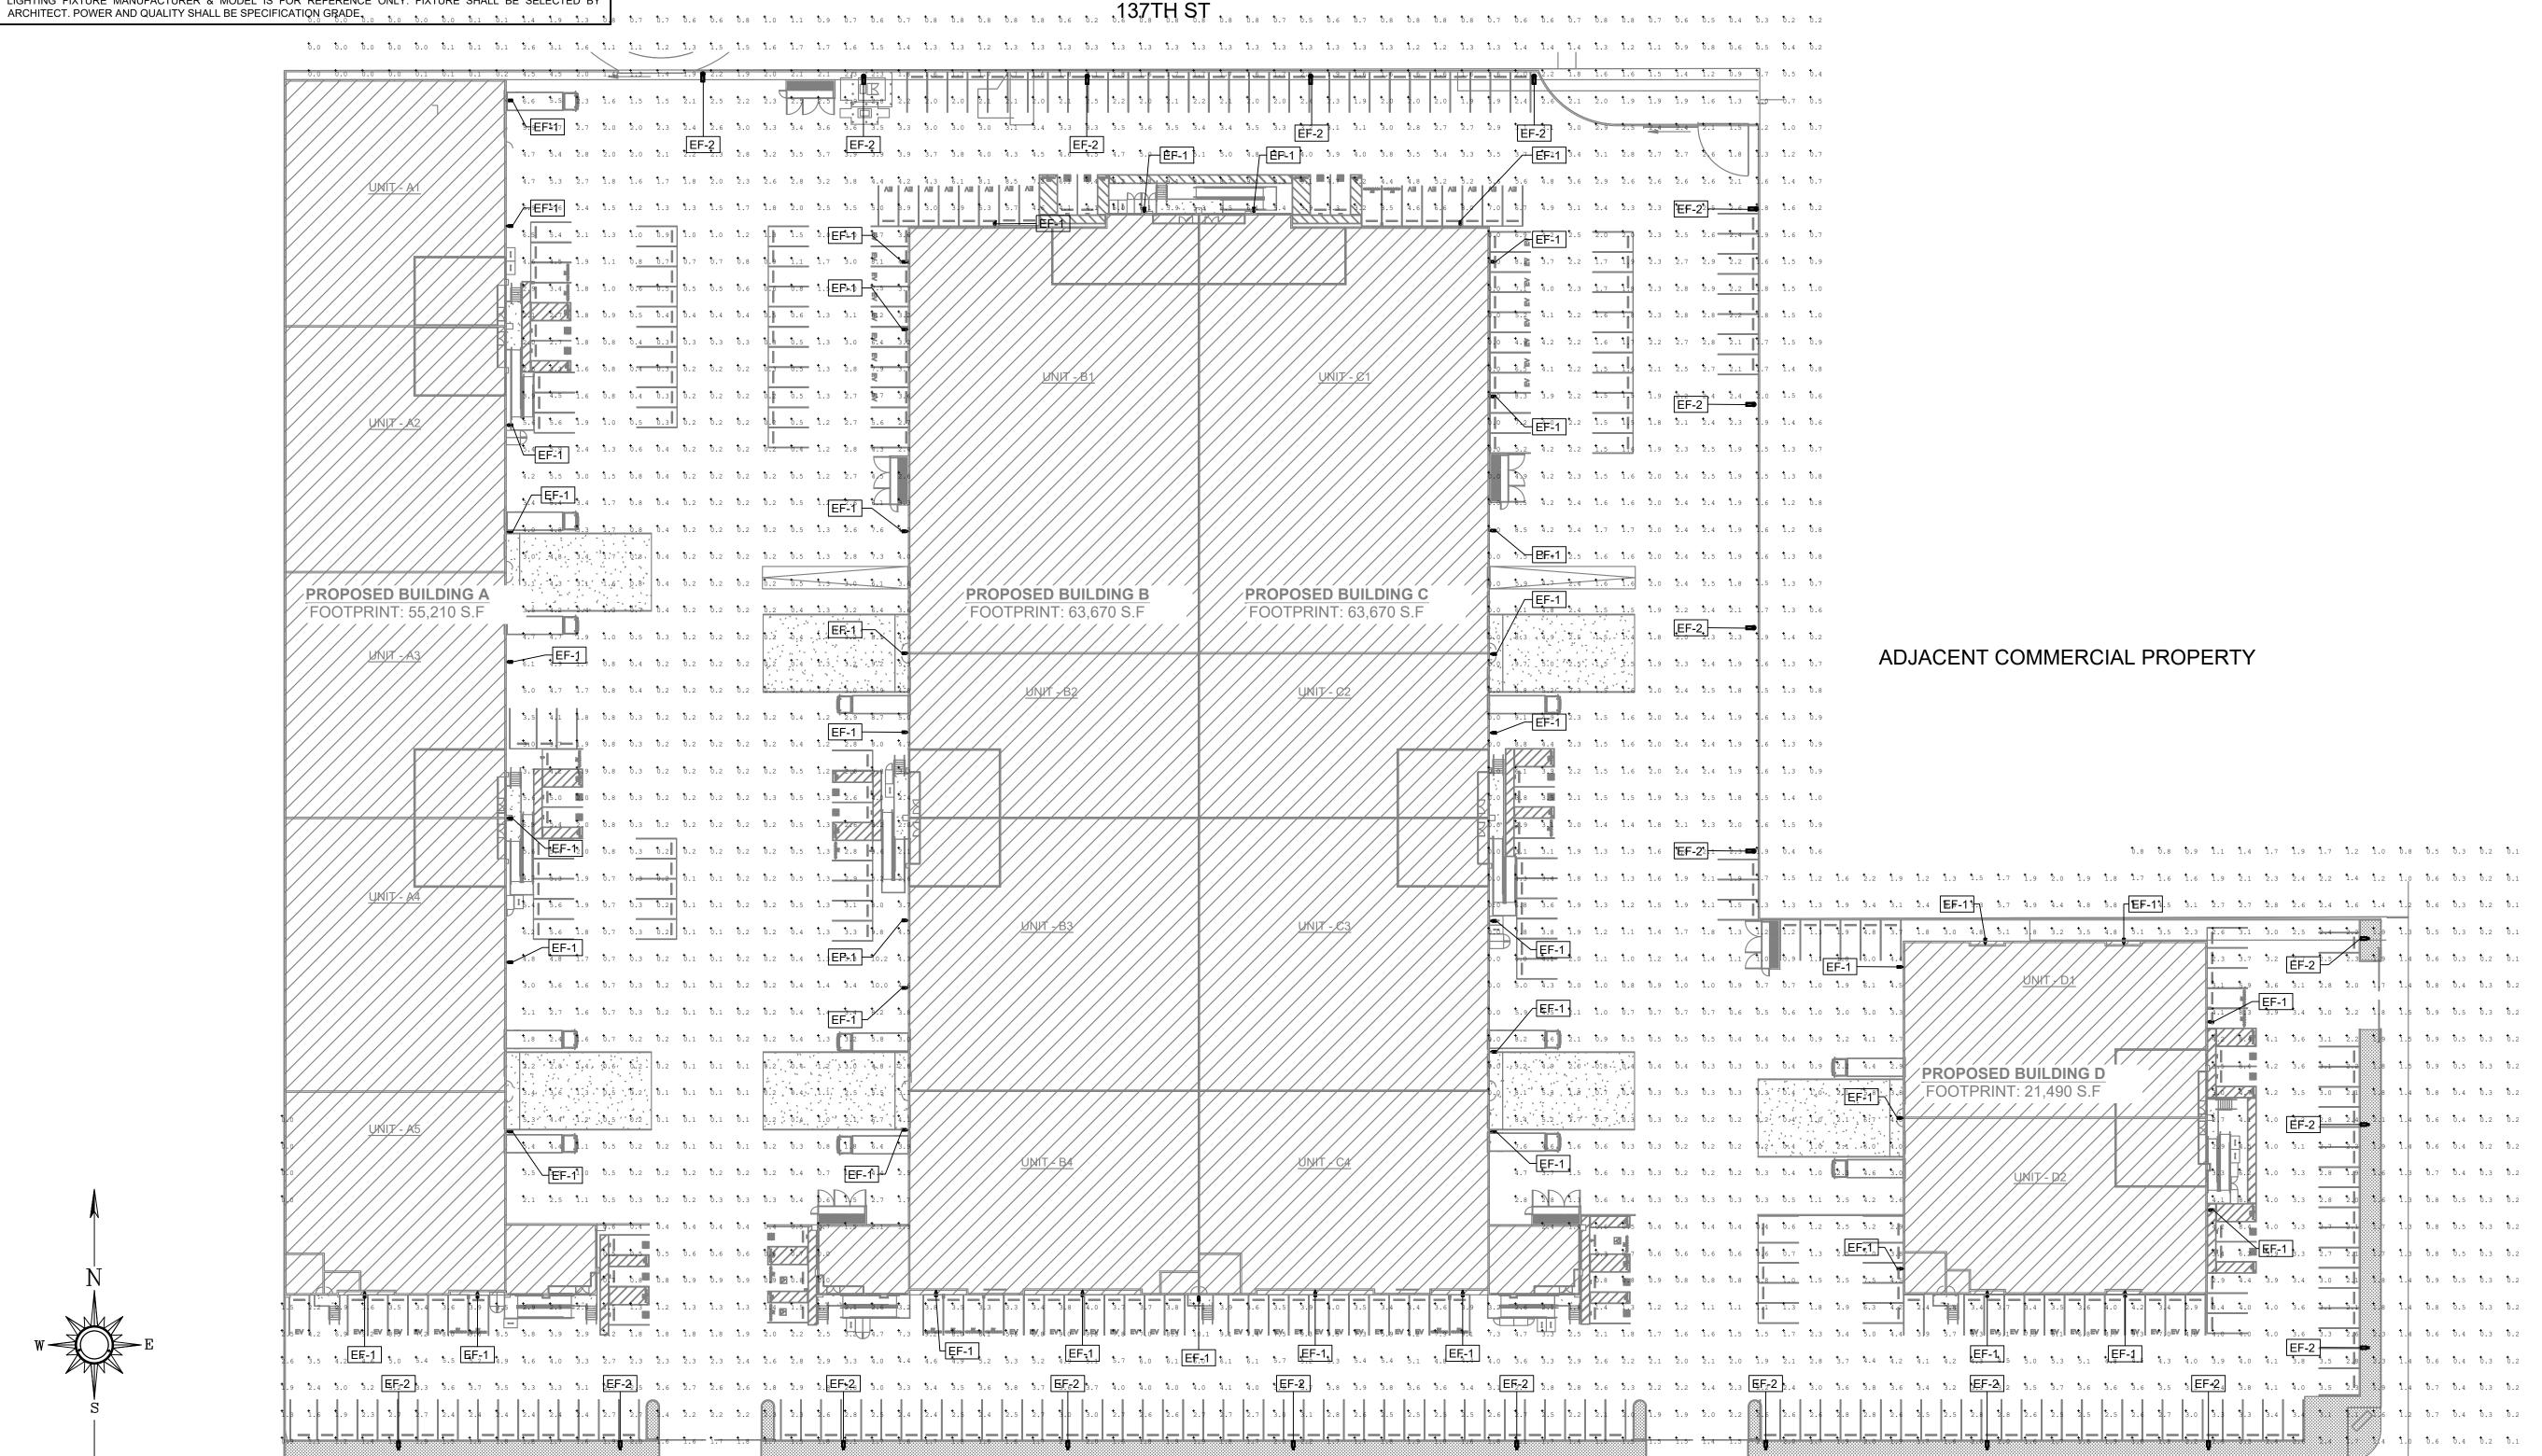
SHEET TITLE:

	LIGHTING FIXTURE SCHEDULE			
TYPE	DESCRIPTION	LAMP	VOLT	WATT
EF-1	LED EXT. WALL MTD. LIGHT, MH: 25'-0" W/ MOTION AND PHOTO SENSOR OR THRU ASTRONOMICAL TIME CLOCK LITHONIA DSX1 LED SERIES OR APPROVED EQUAL	LED	208	104
EF-2	LED EXT. POLE AREA LIGHT, MH: 40'-0" W/ MOTION AND PHOTO SENSOR OR THRU ASTRONOMICAL TIME CLOCK LITHONIA DSX1 LED SERIES OR APPROVED EQUAL	LED	208	167

I. FIXTURE SHALL HAVE MIN. OF 10 YEARS MANUFACTURER WARRANTY ON ALL COMPONENTS.


- FIXTURES SHALL HAVE APPROPRIATE U.L. LABEL (i.c., DAMP OR WET) AS REQUIRED BY CODES AND ORDINANCES. 3. FIXTURES SHALL INCLUDE ALL ACCESSORIES FOR INSTALLATION ACCORDING TO MANUFACTURER'S SHOP DRAWINGS AND AS REQUIRED BY CODES AND LOCAL ORDINANCES. . PRIOR TO ORDERING ANY LIGHTING EQUIPMENT, THE CONTRACT OR SHALL COORDINATE ALL FIXTURE
- LOCATIONS WITH ARCHITECTURAL REFLECTED CEILING PLANS AND CEILING CAVITY DEPTHS. ALL LAMPS SHALL BE PROVIDED AND INSTALLED ACCORDING TO THE ATTACHED FIXTURE SCHEDULE AND SPECIFICATIONS. ENSURE COMPATIBILITY BETWEEN FIXTURE, LAMP(S) AND BALLAST(S).
- . CONTRACTOR SHALL VERIFY FIXTURE VOLTAGES AND CEILING TRIM COMPATIBILITY PRIOR TO ORDERING PROVIDE APPROVED FIRE-RATED ENCLOSURES FOR ALL LIGHTING FIXTURES LOCATED IN FIRE-RATED CEILINGS. LIGHTING FIXTURE CATALOG NUMBERS ARE SERIES TYPE ONLY. PROVIDE ALL NECESSARY HARDWARE AS
- REQUIRED BY THE SPECIFICATIONS, DRAWINGS, AND PROJECT CONDITIONS FOR A COMPLETE INSTALLATION. ALL FIXTURES SHALL BE ORDERED WITH APPROPRIATE BALLAST(S) THAT HAVE U.L. AND CBM LABELS. PROVIDE MULTIPLE BALLASTS FOR DUAL-LEVEL SWITCHING AND WIRING AS INDICATED ON THE PLANS. 10. ENSURE COMPATIBILITY OF ALL LIGHTING SYSTEM COMPONENTS, ESPECIALLY DIMMED SYSTEMS. FIXTURES, LAMPS, BALLAST(S), AND DIMMING SYSTEMS/INDIVIDUAL CONTROLS MUST BE FACTORY CERTIFIED COMPATIBLE
- FOR FULL RANGE OF DIMMING COMPATIBILITY. 11. LIGHTING FIXTURE MANUFACTURER & MODEL IS FOR REFERENCE ONLY. FIXTURE SHALL BE SELECTED BY

STATISTICS										
DESCRIPTION	SYMBOL	AVG	MAX	MIN	AVG/MIN	MAX/MIN				
PARKING AREA	+	3.76	10.10	0.70	5.37	14.43				








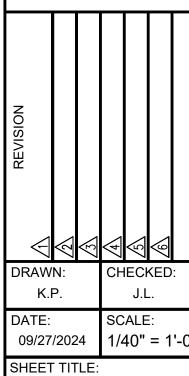

PHOTOMETRIC PLAN

E001

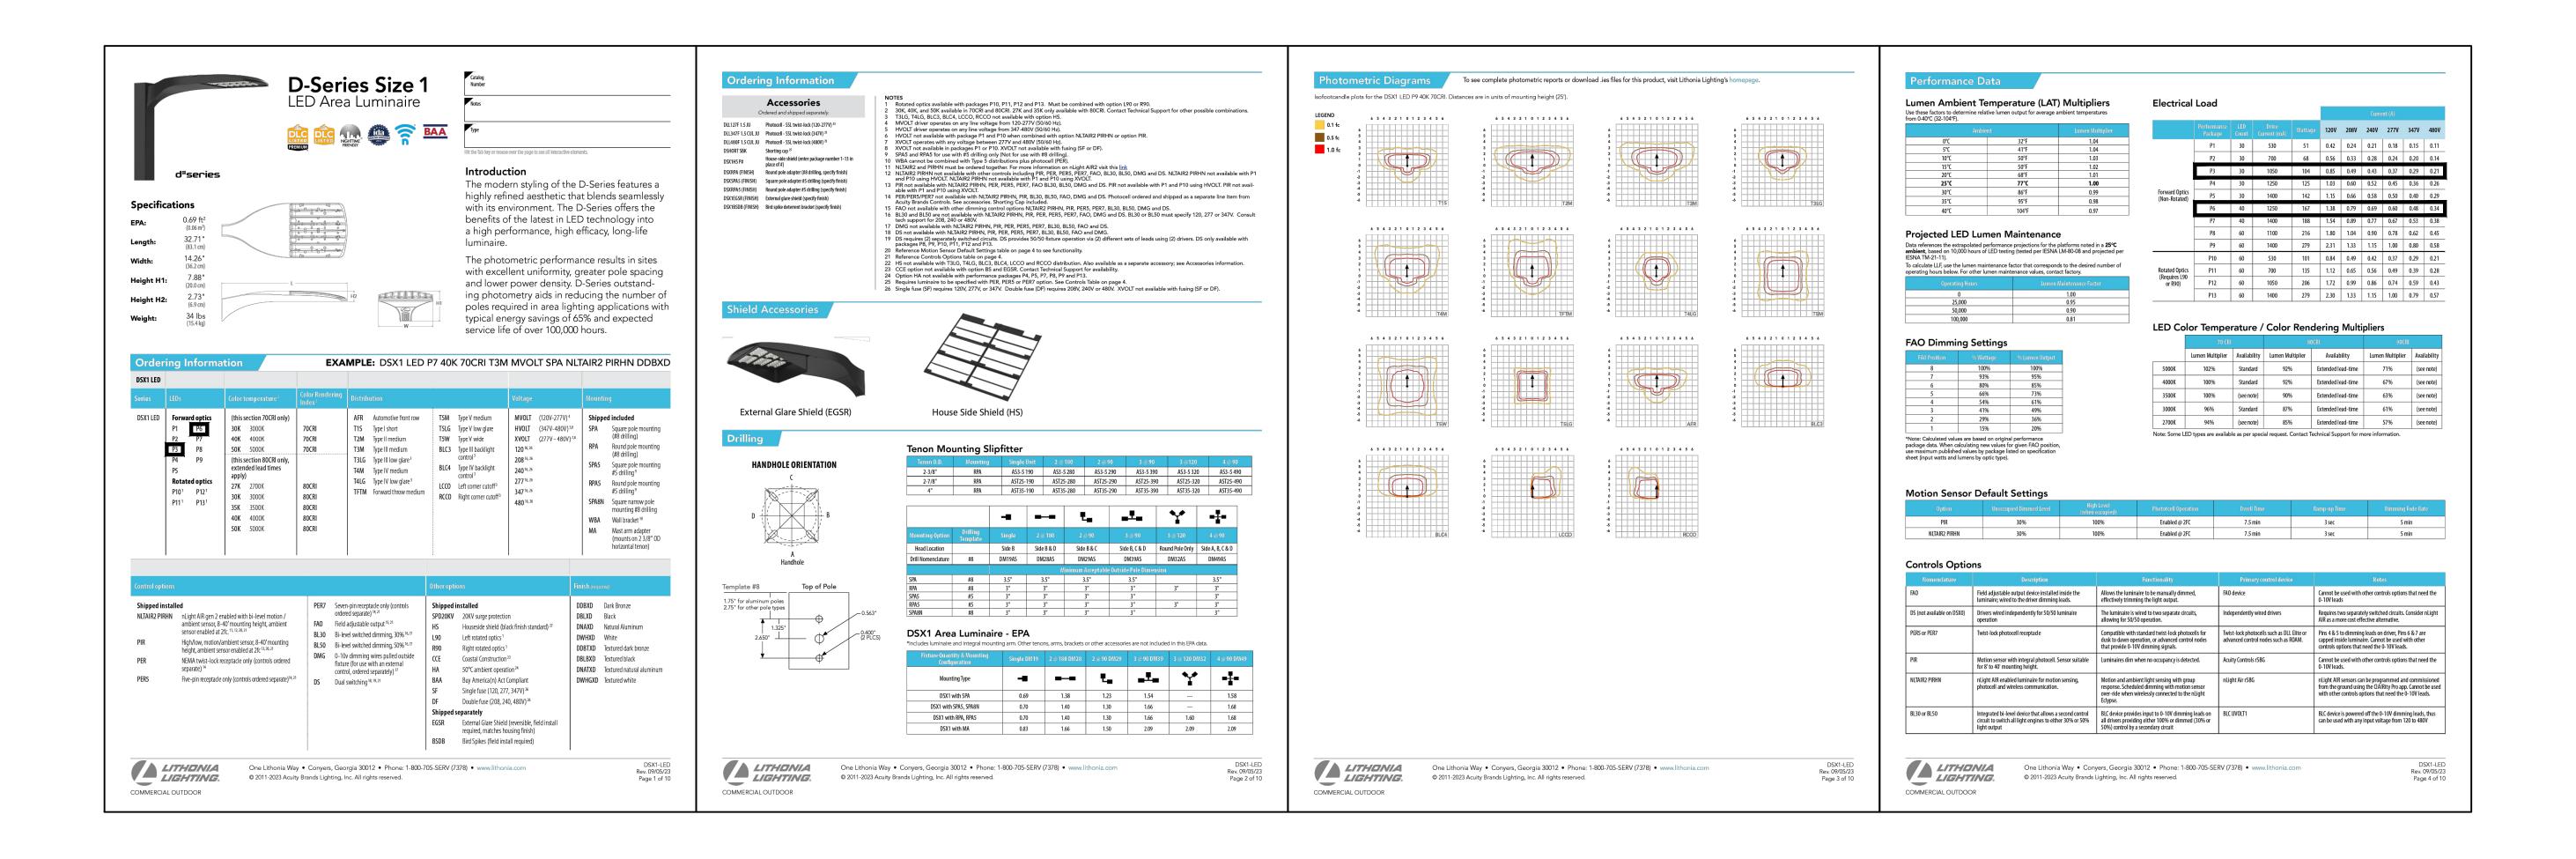

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CONSTRUCTION OF THE CONS

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GARDENA

TERRENO

W. 139TH ST. DENA, CA 90249


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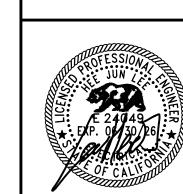
DATE: SCALE:
09/27/2024 N.T.S.

SHEET TITLE:

SPECIFICATIONS

E002



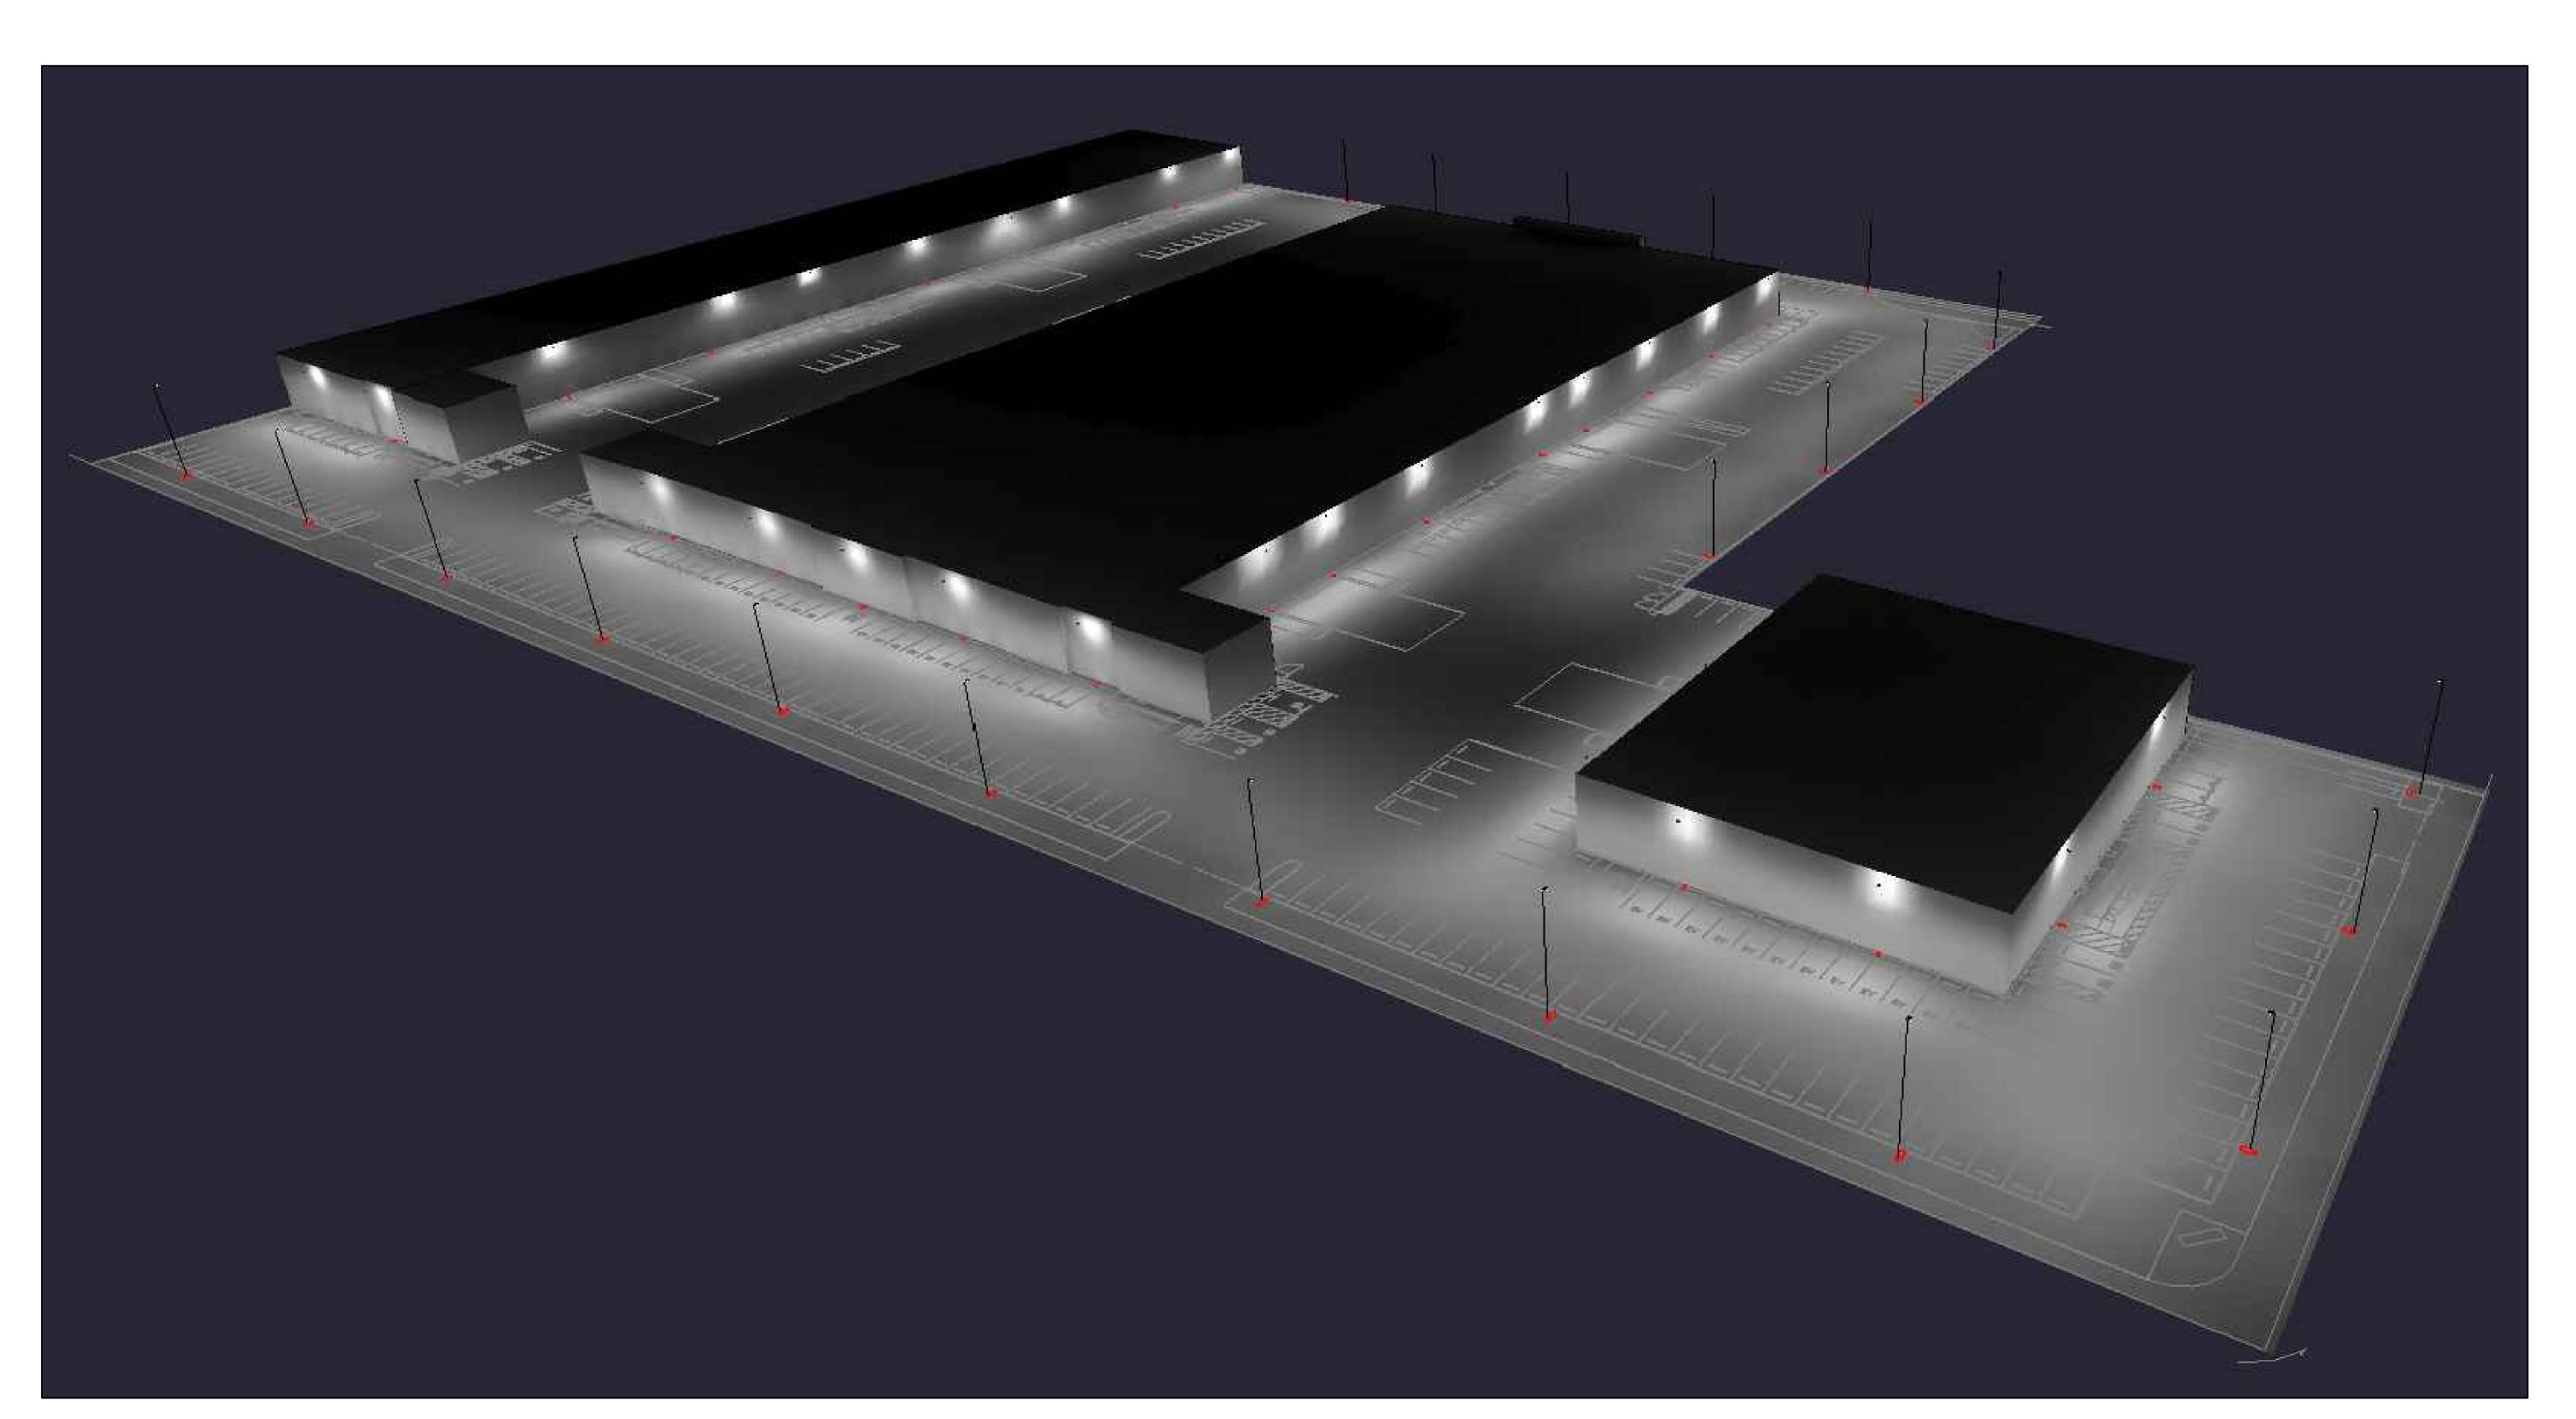

TERRENO GARDENA

SCALE: N.T.S.

DATE: 09/27/2024 SHEET TITLE:

PHOTOMETRIC RENDERING

E003